

SOUTH LA FAIRGROUNDS
SOFTBALL BACKSTOPS REPLACEMENT
DONALDSONVILLE, LOUISIANA
MAY 2023
ASCE PROJECT No. 058-005-02

SHEET INDEX


SHEET NUMBER	SHEET TITLE
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LOCATION MAP
0 200' 400'
SCALE: 1"=200'

SCOPE OF WORK:
BACKSTOP AND NETTING REPLACEMENTS

LICENSURE CLASSIFICATION REQUIREMENTS:
CLASS IV MUNICIPAL AND PUBLIC WORKS CONSTRUCTION



SCHEDULE OF REVISIONS

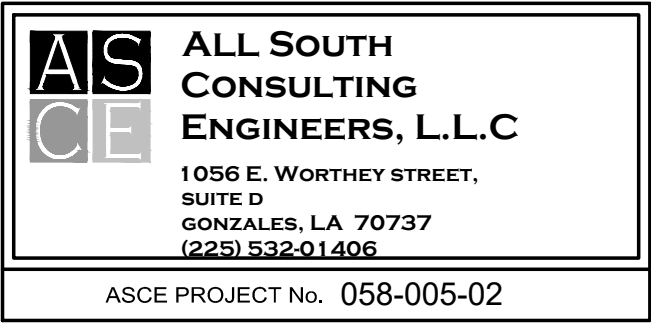DATE:	DESCRIPTION	APPROVED:



PARISH PRESIDENT
CLINT COINTMENT

PARISH COUNCIL MEMBERS

ALVIN "COACH" THOMAS JR. - DISTRICT 1

JOEL ROBERT - DISTRICT 2

TRAVIS TURNER - DISTRICT 3

COREY ORGERON - DISTRICT 4

DEMPSEY LAMBERT - DISTRICT 5

CHASE MELANCON - DISTRICT 6

AARON LAWLER - DISTRICT 7

TERI CASSO - DISTRICT 8

DAL WAGUESPACK - DISTRICT 9

JOHN CAGNOLATTI - DISTRICT 10

MICHAEL MASON - DISTRICT 11



Thomas J. Duencel

THOMAS J. DUENCKEL, P.E. LA. LICENSE #23903
ALL SOUTH CONSULTING ENGINEERS, LLC

5-23-23

DATE

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GENERAL NOTES:

1.

THE CONTRACTOR SHALL CONTACT LOUISIANA ONE CALL (811 OR 1-800-272-3020) WITHIN 5 DAYS OF RECEIVING THE EXECUTED CONTRACT. THE CONTRACTOR SHALL CONTACT ALL UTILITY COMPANIES THAT LOUISIANA ONE CALL SHOWS AS HAVING UTILITIES IN THE PROJECT AREA AT LEAST 5 WORKING DAYS PRIOR TO BEGINNING ANY CONSTRUCTION ACTIVITIES.
2.

THE CONTRACTOR SHALL BE RESPONSIBLE FOR DETERMINING THE EXACT LOCATION, DEPTH, AND SIZE OF ALL UNDERGROUND UTILITIES (SEWER, WATER, GAS, TELEPHONE & DRAIN LINES) AND STRUCTURES BEFORE BEGINNING OF ANY CONSTRUCTION ACTIVITY AND SHALL BE LIABLE FOR ANY DAMAGE CAUSED BY FAILURE TO COMPLY WITH THESE INSTRUCTIONS.
3.

THE CONTRACTOR SHALL COORDINATE THE RELOCATION AND/OR ALTERATION OF ALL PRIVATE UTILITIES WITH THE RESPONSIBLE UTILITY COMPANY. ALL PRIVATE UTILITY RELOCATION COSTS (GAS, CABLE, TELEPHONE, ELECTRICAL, ETC.) SHALL BE BORNE BY OWNER OF UTILITY COMPANY, UNLESS ALTERATIONS ARE DUE TO THE NEGLIGENCE OF THE CONTRACTOR.
4.

THE CONTRACTOR SHALL AT ALL TIMES CONDUCT HIS OPERATION TO ENSURE THE LEAST INCONVENIENCE TO THE GENERAL PUBLIC, ADJACENT PROPERTY OWNERS AND BUSINESSES. CONTRACTOR SHALL PROVIDE AND MAINTAIN ACCESS TO ALL PROPERTIES AND TRAFFIC FLOW IN ROADWAYS AND DRIVEWAYS AT ALL TIMES.
5.

THE CONTRACTOR SHALL CONTACT ENGINEER'S OFFICE IMMEDIATELY CONCERNING ANY CONFLICTS THAT ARISE DURING THE COURSE OF CONSTRUCTION ACTIVITIES.
6.

THE CONTRACTOR IS RESPONSIBLE FOR REMOVAL OF DIRT AND DEBRIS FROM THE STREET AND SITES GENERATED BY CONSTRUCTION ACTIVITIES ON A DAILY BASIS.
7.

THE CONTRACTOR SHALL PROTECT ADJACENT PROPERTY AND IS RESPONSIBLE FOR REPLACING OR REPAIRING ALL DAMAGE TO ADJACENT PAVEMENT, SODDING AND FENCING WHICH CAN BE RESULTED FROM THE CONTRACTOR'S CONSTRUCTION ACTIVITIES AT NO ADDITIONAL COST TO THE OWNER.
8.

THE CONTRACTOR SHALL PREVENT WASHOUT OF SOILS ONTO EXIST ROADWAYS. CONTRACTOR TO CLEAN ALL AREAS OF WASHOUT ONTO ROADWAYS AFTER EACH RAIN EVENT (THE CONTRACTOR SHALL SUBMIT AN EROSION CONTROL PLAN FOR APPROVAL TO OWNER, AND ENGINEER PRIOR TO START OF CONSTRUCTION).
9.

THE CONTRACTOR SHALL MAINTAIN A SAFE DISTANCE FROM ALL ENERGIZED POWER LINES IN ACCORDANCE WITH OSHA, NEC, AND ENTERGY REQUIREMENTS. IF REQ'D TO DE-ENERGIZE, CONTRACTOR TO CO-ORDINATE WITH THE RESPECTIVE UTILITY COMPANY (ANY CHARGES ASSOCIATED WITH DE-ENERGIZING LINES TO BE PAID BY THE CONTRACTOR).
10.

DIMENSIONS AND/OR ELEVATIONS MARKED ARE APPROXIMATE. CONTRACTOR SHALL VERIFY ACTUAL DIMENSIONS IN THE FIELD AND ANY DISCREPANCIES ARE TO BE DOCUMENTED AND SUBMITTED TO THE OWNERS REPRESENTATIVE AT THE TIME OF DISCOVERY.
11.

DRAWINGS MARKED THUS (N.T.S.) ARE NOT SHOWN TO SCALE.
12.

DRAWINGS ARE GENERALLY TO SCALE, BUT SHOULD NOT BE SCALED. N.T.S. IS SHOWN ONLY WHERE DRAWING IS OBVIOUSLY OUT OF SCALE.
13.

THE CONTRACTOR SHALL BE SOLELY RESPONSIBLE FOR MEANS, METHODS, TECHNIQUES, SEQUENCES, AND PROCEDURES OF CONSTRUCTION WHILE MAINTAINING SAFE WORK CONDITIONS. THE CONTRACTOR SHALL OBSERVE ALL OSHA AND ANY OTHER REGULATIONS PERTAINING TO SAFETY.
14.

THE CONTRACTOR SHALL VISIT THE SITE AND EXAMINE AND NOTE ALL CONDITIONS AS TO THE CHARACTER AND EXTENT OF THE WORK INVOLVED, BEFORE BEGINNING OF ANY CONSTRUCTION ACTIVITY. CONTRACTOR SHALL ASSUME ALL THE RESPONSIBILITY FOR ALL LAYOUT OF WORK.
15.

THE CONTRACTOR (AND/OR SUBCONTRACTOR) SHALL USE EXTREME CAUTION AND OBSERVE ALL POSTED SPEED LIMIT SIGNS.
16.

THE CONTRACTOR SHALL ENSURE THAT ALL VEHICLES USED ON THIS PROJECT FOR TRANSPORTATION OF MATERIALS ARE UNDER THE MAXIMUM ALLOWABLE LOADING FOR ROADS AND BRIDGES USED TO ACCESS THIS PROJECT.
17.

ALL TREES LOCATED WITHIN THE LIMITS OF CONSTRUCTION AND/OR OUTSIDE OF DISTURBED AREAS SHALL BE PROTECTED. THE CONTRACTOR IS RESPONSIBLE FOR PROTECTING ALL TREES FROM SITE ACTIVITIES. TREE PROTECTION FENCES SHALL BE INSTALLED PRIOR TO COMMENCEMENT OF ANY SITE PREPARATION WORK (CLEARING, GRUBBING, EXCAVATION OR GRADING) AND SHALL BE MAINTAINED THROUGHOUT ALL PHASES OF CONSTRUCTION (AT NO DIRECT PAY).
18.

EXCESS EXCAVATED MATERIAL DERIVED FROM DRAINAGE STRUCTURE INSTALLATION, WATER MAIN, SEWER FORCE MAIN, DRAIN LINES, AND NOT USED AS SELECT BACKFILL, SHALL BE HAULED-OFF FROM SITE AS DIRECTED BY PROJECT ENGINEER. ALL DISPOSAL OF EXCESS EXCAVATED MATERIAL SHALL BE AT CONTRACTOR'S EXPENSE.
19.

ANY MATERIALS REMOVED DURING CONSTRUCTION AND DEEMED UNUSABLE SHALL BECOME THE PROPERTY OF THE CONTRACTOR AND HAULED OFF BEYOND THE LIMITS OF THE PROJECT AT THE CONTRACTOR'S EXPENSE. ANY SALVAGEABLE MATERIALS SHALL BECOME THE PROPERTY OF OWNER AS NOTED IN THE PLANS OR SPECIFICATIONS.

HORTICULTURE REQUIREMENTS:

1.

THE CONTRACTOR SHALL NOTIFY THE PARISH DEPARTMENT OF PUBLIC WORKS (225-686-3030) 7-DAYS PRIOR TO PERFORMING ANY WORK OR REPLACING UTILITY LINES LOCATED BENEATH THE DRIP LINE OF TREES. IF NECESSARY THE CONTRACTOR SHALL SHORE AREA NEAR THE TREES, USE ROOT GUARDS, AND OTHER PRECAUTIONS NECESSARY TO PROTECT THE TREES.
2.

ALL TREE REMOVALS, BRANCH PRUNING, OR ROOT CUTTING, SHALL BE PERFORMED BY A CONTRACTOR PROVIDED LICENSED ARBORIST, APPROVED BY THE PARISH DEPARTMENT OF PUBLIC WORKS/ARBORIST. THE ARBORIST SHALL OBTAIN A PERMIT FROM THE PLANNING DEPARTMENT PRIOR TO WORKING ON ANY CITY TREES (NO DIRECT PAYMENT).
3.

NO EQUIPMENT AND/OR SUPPLIES MAY BE STORED OR PLACED ON UNPAVED SURFACES WITHIN THE DRIP LINE OF A TREE.
4.

ALL EXIST TREES, SHRUBS, AND VEGETATION DISTURBED BY THE CONTRACTOR'S OPERATION, SHALL BE REPLACED IN-KIND OR REPAIRED AND WARRANTED FOR 1-YEAR AT NO DIRECT PAY.
5.

TREE PROTECTION SHALL BE REQ'D AROUND ALL TREES WHEN WORK IS TO BE DONE WITHIN THE CRITICAL ROOT ZONE. (CRZ) OF A TREE AND IN PLACE PRIOR TO START OF CONSTRUCTION. THE CRZ IS ONE FOOT RADIUS FOR EVERY ONE INCH OF DIAMETER BREST HEIGHT OF THE TREE. (NO DIRECT PAYMENT). ANY CONSTRUCTION WITHIN THE CRZ MUST FOLLOW THE TREE PROTECTION DETAILS AND SPECIFICATIONS THAT INCLUDES, BUT NOT LIMITED TO, USING MYCORRHIZAL FUNGAL INOCULATE, TERMITICIDES, MULCHING AND GROWTH REGULATOR.
6.

ALL HOUSE CONNECTIONS AND CURBS WHICH ARE LOCATED WITHIN THE TREE DRIP LINES SHALL BE EXCAVATED BY HAND AT NO DIRECT PAY, NO MECHANICAL TRENCHING WILL BE ALLOWED.
7.

THE CONTRACTOR SHALL BE REQ'D TO SEED ALL PERVIOUS AREAS THAT ARE DISTURBED BY CONSTRUCTION.

DRAINAGE NOTES:

1.

THE CONTRACTOR SHALL BE RESPONSIBLE FOR MAINTAINING DRAINAGE THROUGHOUT THE ENTIRE CONTRACT.
2.

THE CONTRACTOR SHALL NOT BE ALLOWED TO IMPEDE THE DRAINAGE OF ANY AREAS OR CAUSE ANY OBSTRUCTIONS TO ANY WATER RUN -OFF DURING CONSTRUCTION.
3.

THE CONTRACTOR SHALL RE-GRADE ALL AREAS ALTERED BY CONSTRUCTION ACTIVITIES TO PROVIDE POSITIVE DRAINAGE. ALL WORK SHALL BE IN A MANNER ACCEPTABLE TO THE OWNER. IF THE CONTRACTOR DETERMINES THAT ANY AREAS AFFECTED BY CONSTRUCTION ACTIVITIES CANNOT BE RE-GRADED TO DRAIN, THE CONTRACTOR SHALL DOCUMENT (I.E;TAKE ELEVATION, PICTURES, ETC.) OF EXIST CONDITIONS AND INFORM ENGINEER PRIOR TO CONSTRUCTION.
4.

THE CONTRACTOR SHALL INSTALL TEMPORARY DAMS, BY-PASS PUMPS, OR STORM DRAIN PIPES, IN ORDER TO EXPEDITE DRAINAGE THROUGHOUT THE PROJECT DURING CONSTRUCTION. THE CONTRACTOR SHALL MAKE SURE TO AVOID ANY PONDING OF WATER IN ROADWAYS. (NO DIRECT PAY.)
5.

THE CONTRACTOR SHALL BE RESPONSIBLE FOR INSTALLING AND MAINTAINING EROSION CONTROL AND POLLUTION PREVENTION MEASURES THROUGHOUT THE PROJECT TO PROTECT ALL ADJACENT WATERSHEDS. ALL EROSION CONTROL AND POLLUTION MEASURES SHALL MEET THE REQUIREMENTS OF ALL STATE, FEDERAL, AND LOCAL GOVERNING AUTHORITIES. CONTRACTOR SHALL SUBMIT TO THE OWNER AND ENGINEER, A STORM WATER POLLUTION PREVENTION PLAN DETAILING ALL PROPOSED MEASURES. (NO DIRECT PAY).

BACKSTOP DESIGN:

1.

THE EXISTING BACKSTOP BEHIND HOME PLATE IS TO BE COMPLETELY DEMOLISHED. THE CONTRACTOR SHALL REMOVE AND DISPOSE OF EXISTING CONCRETE FOOTINGS, POLES, WIRE FENCING AND NETTING.
2.

THE NEW BACKSTOPS ON FIELDS #1 WILL HAVE THE SAME FOOT PRINT AS THE EXISTING. THE BACKSTOP ON FIELD #2 AND FIELD #3 WILL BE MODIFIED AS SHOWN.
3.

THE NEW BACKSTOP WILL CONSIST OF A BRICK/CONCRETE WALL WITH SUPPORT POLES SET IN THE WALL. THE POLES WILL SUPPORT NEW NETTING FROM THE TOP OF THE POLES AND NETTING WILL BE TIED INTO THE TOP OF THE WALL.

NETTING SYSTEM DESIGN:

1.

THE SUPPLIER OF THE NETTING SYSTEM WILL BE RESPONSIBLE FOR THE FOLLOWING:
- a.

PROVIDE THE SERVICES OF AN ENGINEER REGISTERED WITHIN THE STATE OF LOUISIANA TO CERTIFY DESIGN OF THE POLE FOUNDATION.

BASIS OF DESIGN:

1.

THE BASIS OF DESIGN FOR THIS PROJECT IS SPORTSFIELD SPECIALTIES OR EQUAL. SEE SPECIFICATIONS FOR DETAILS.

COORDINATION OF WORK:

1.

THE CONTRACTOR IS MADE AWARE THAT THERE IS ANOTHER CONSTRUCTION CONTRACT BEING LET AT OR AROUND THE SAME TIME AS THIS WORK WHICH INVOLVES INSTALLING NEW LIGHT POLES AROUND ALL THREE FIELDS. THIS WORK ALSO INCLUDES THE DEMOLITION OF EXISTING POLES AND IN-GROUND ELECTRICAL. THESE WORKS ARE ADJACENT TO THE BACKSTOP AREA AND THE CONTRACTOR SHALL COORDINATE ALL WORK WITH THE LIGHTING CONTRACTOR (SEE SHEETS 4-6 FOR ESTIMATED LOCATION).

DO NOT DIG

THE CONTRACTOR SHALL CONTACT LA ONE CALL (811) AT LEAST TWO (2) BUT NO MORE THAN FIVE (5) FULL WORKING DAYS BEFORE WORK BEGINS. THE CONTRACTOR IS CAUTIONED THAT THERE ARE BURIED UTILITIES ON AND/OR ADJACENT TO THIS SITE. WHILE THE ENGINEER HAS PERFORMED REASONABLE RESEARCH TO DETERMINE HORIZONTAL AND VERTICAL LOCATIONS OF EXIST BURIED UTILITIES THIS INFORMATION HAS NOT BEEN FIELD VERIFIED. IT IS THE CONTRACTOR'S RESPONSIBILITY TO VERIFY HORIZONTAL AND VERTICAL LOCATIONS OF ALL EXIST BURIED UTILITIES THAT WILL AFFECT THE PROPOSED WORK.

REVISIONS	DATE:	REMARKS:	APP'D					

THOMAS J. QUENNER

PROFESSIONAL ENGINEER

STATE OF LOUISIANA

REG. NO. 23903

EXPIRATION DATE 12/31/2025

IN CIVIL ENGINEERING

ALL SOUTH CONSULTING, L.L.C

ENGINEERS, L.L.C

1056 E. WORTHLEY STREET

SUITE 200

GONZALES, LA 70737

(504) 536-1400

DESIGNED BY:	TJD	DRAWN BY:	MM	CHECKED BY:	SCB
DATE:	4/19/2023	SCALE:	AS SHOWN	SUB NO.	058-005-02

SOUTH LA FAIRGROUNDS

SOFTBALL BACKSTOPS REPLACEMENT

DONALDSONVILLE, LOUISIANA

GENERAL NOTES

SHEET NO.

2

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EXISTING SITE PLAN
SCALE: 1" = 40'



SOUTH LA FAIRGROUNDS
SOFTBALL BACKSTOPS REPLACEMENT
DONALDSONVILLE, LOUISIANA

SHEET NO.
3

EXISTING SITE PLAN


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JOB NO.	058-005-02

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DRAWN BY:	MM
CHECKED BY:	SCB

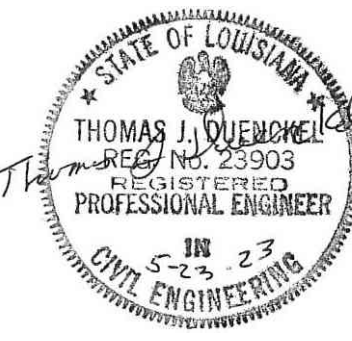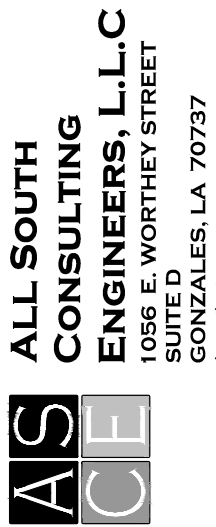



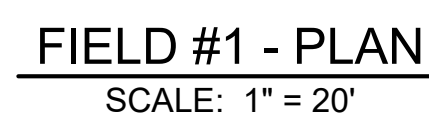

REVISIONS

DATE:	REMARKS:	APP'D



- LEGEND**

 -  CHAIN FENCE (EXIST)
 -  PROPOSED NETTING
 -  APPROXIMATE NET SUPPORT POLE LOCATION
 -  FIXTURE LIGHTING (APPROX. LOCATION)

STATE OF LOUISIANA
 THOMAS J. DUVENOW
 REG. NO. 23903
 REGISTERED
 PROFESSIONAL ENGINEER
 IN
 CIVIL ENGINEERING
 5-23-23

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SCALE:	AS SHOWN	MM	DRAWN BY:
JOB NO.	058-005-02	SCB	CHECKED BY:


**SOUTH LA FAIRGROUNDS
SOFTBALL BACKSTOPS REPLACEMENT
DONALDSONVILLE, LOUISIANA**

FIELD #1 - PLAN AND ELEVATIONS


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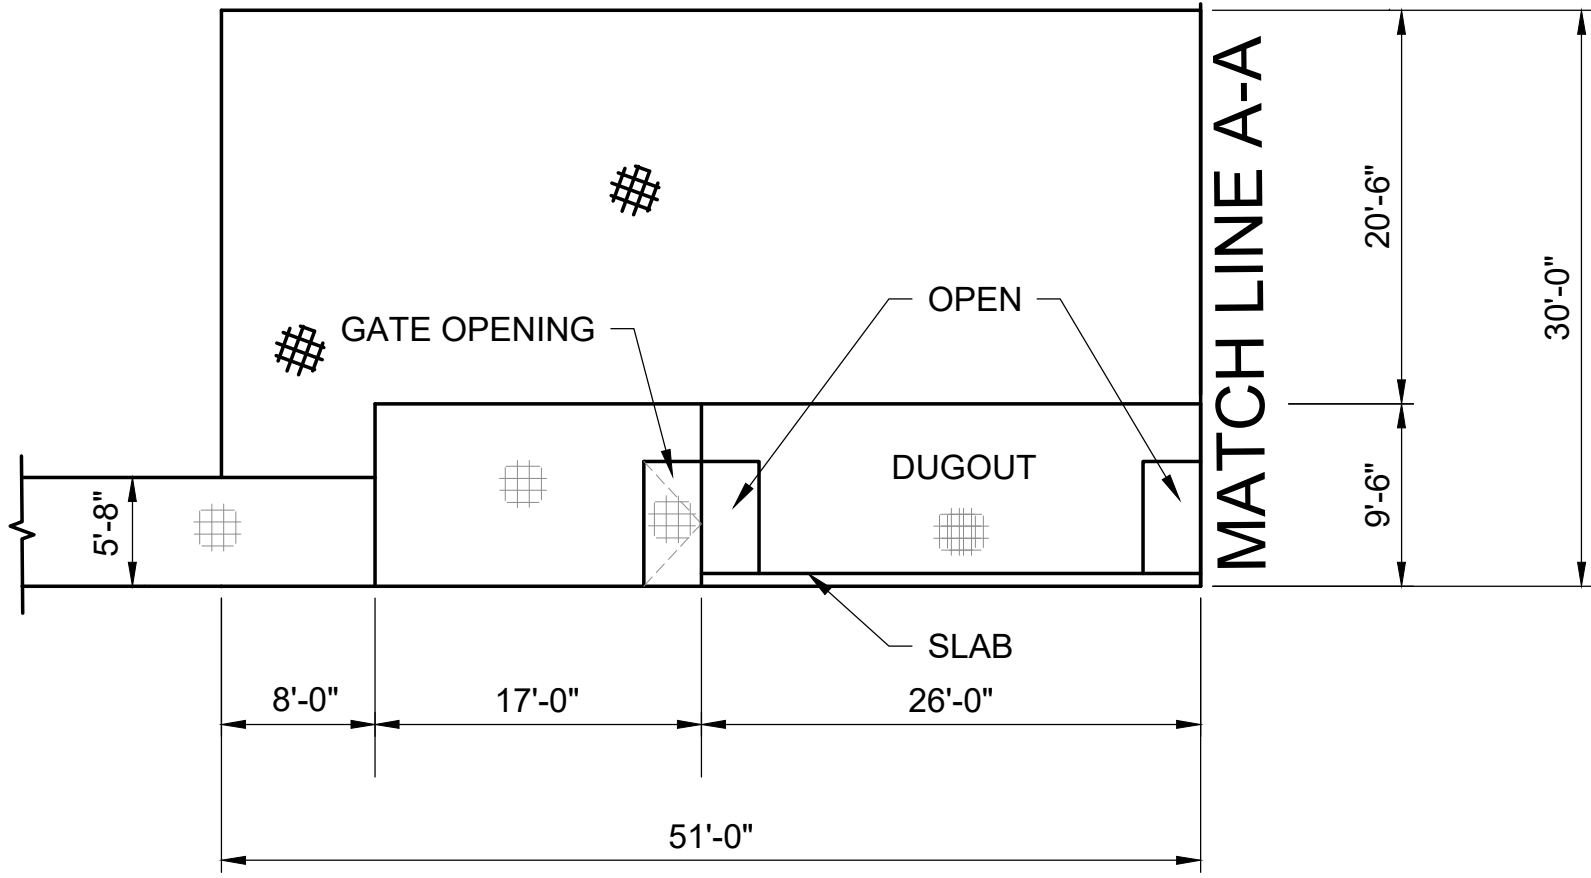
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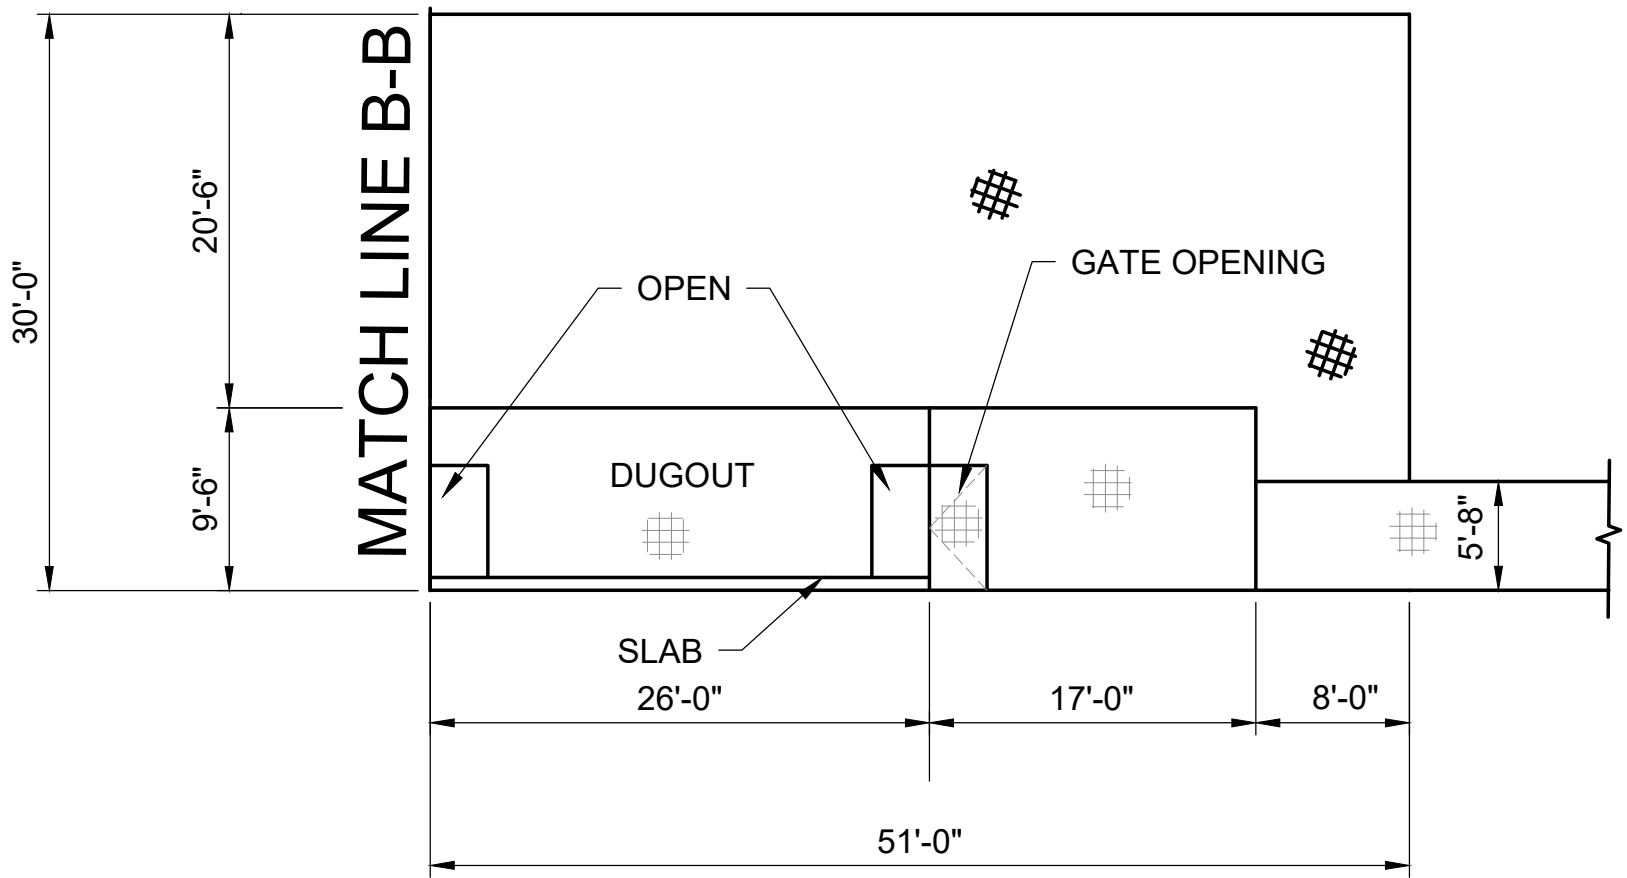
BACKSTOP PLAN
SCALE: 1" = 10'



BACKSTOP ELEVATION
(WINGS SHOWN AT 90°)
SCALE: 1" = 10'

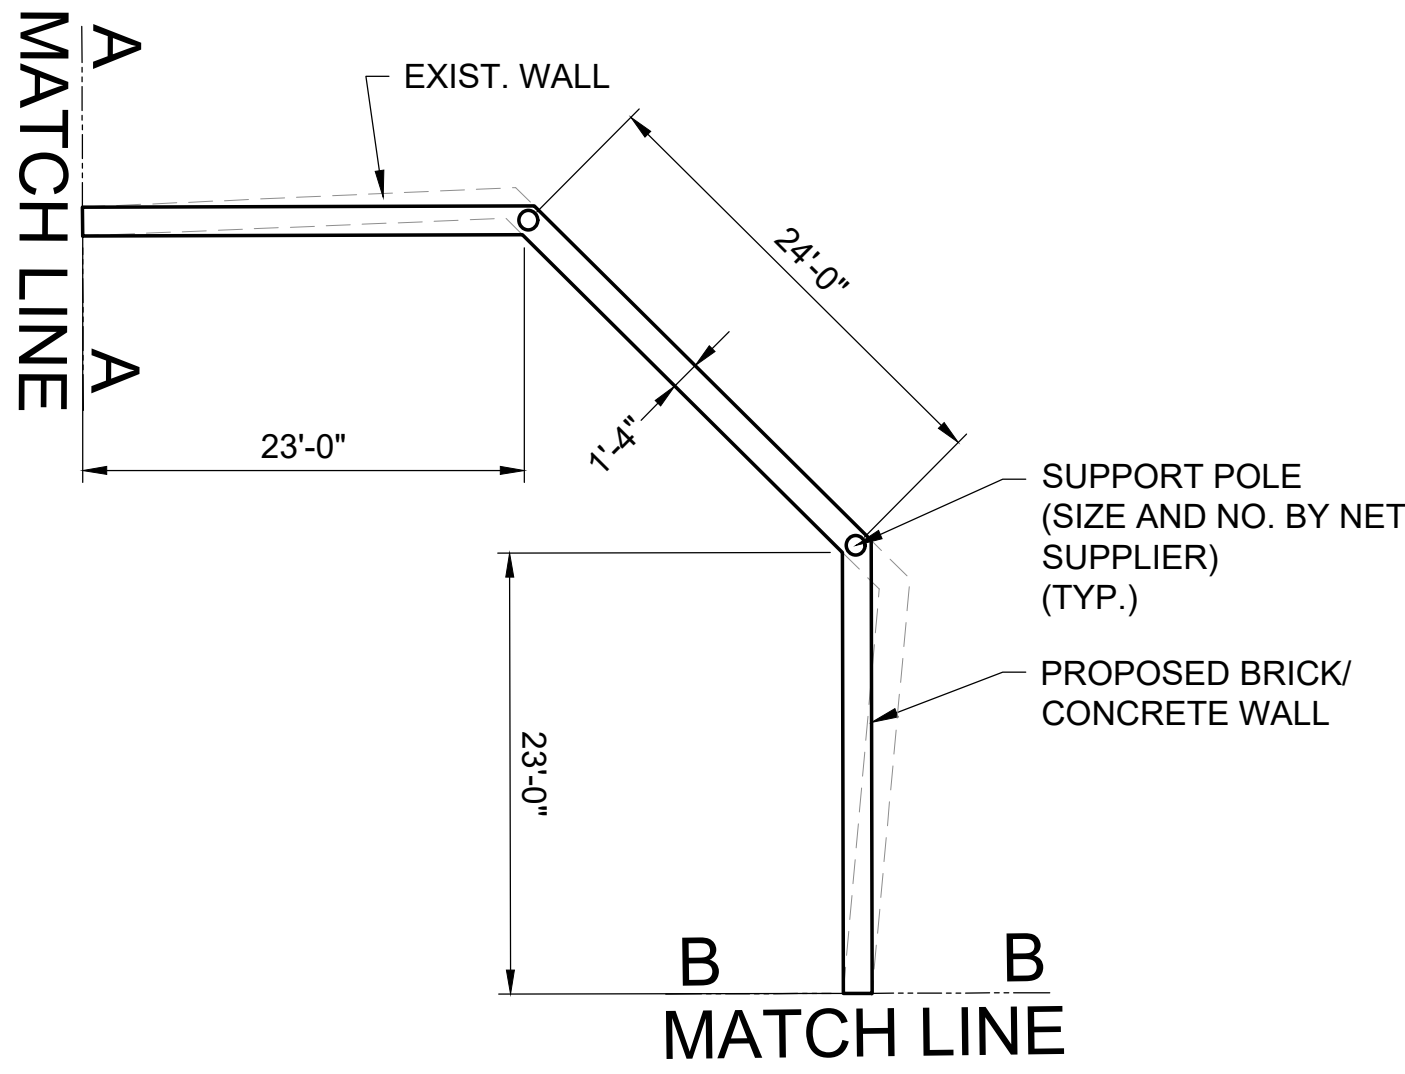

RIGHT FIELD ELEVATION
SCALE: 1" = 10'

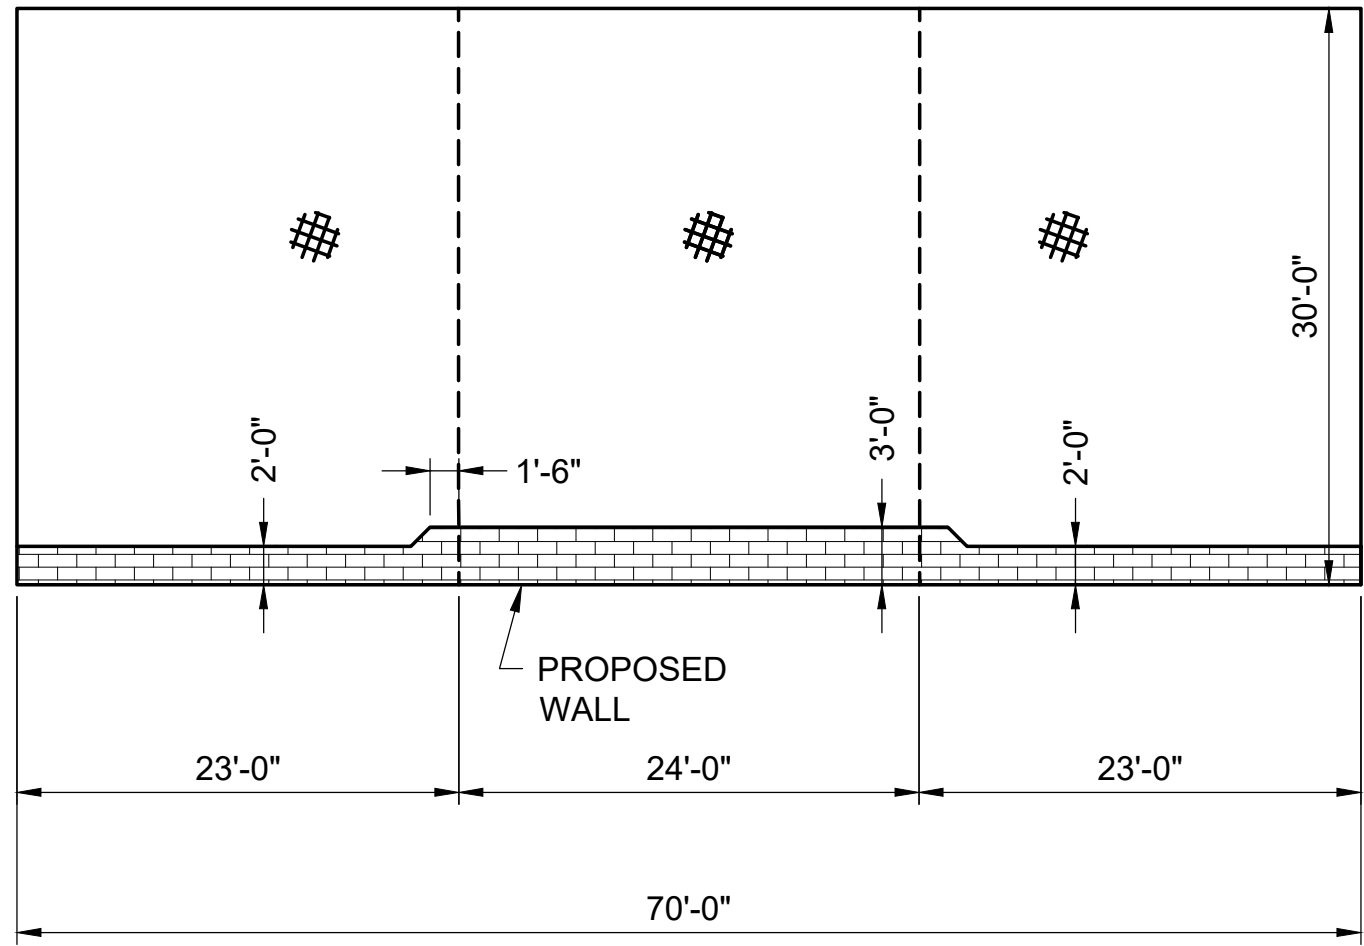


LEFT FIELD ELEVATION
SCALE: 1" = 10'

- NOTES:
- BACKSTOP WINGS SHALL BE BUILT IN LINE WITH DUGOUT (CONTRACTOR TO LAYOUT FOR ENGINEER APPROVAL PRIOR TO CONSTRUCTION)
 - ELEVATION DETAILS SHOW PROPOSED NETTING TERMINATING AT TOP OF EXISTING DUGOUTS, CHAINLINK FENCING, AND/OR PROPOSED WALL. SEE SHEETS 7 AND 8 FOR ATTACHMENT DETAILS.
 - NET SUPPORT POLE LOCATIONS, SIZE, AND FOUNDATION REQUIREMENTS TO BE SPECIFIED BY NETTING SYSTEM SUPPLIER.
 - THE BASIS OF DESIGN FOR THIS PROJECT IS SPORTSFIELD SPECIALTIES OR EQUAL. SEE SPECIFICATIONS FOR DETAILS.

LEGEND	
	CHAIN FENCE (EXIST)
	PROPOSED NETTING
	APPROXIMATE NET SUPPORT POLE LOCATION
	FIXTURE LIGHTING (APPROX. LOCATION)

REVISIONS	
DATE:	REMARKS:

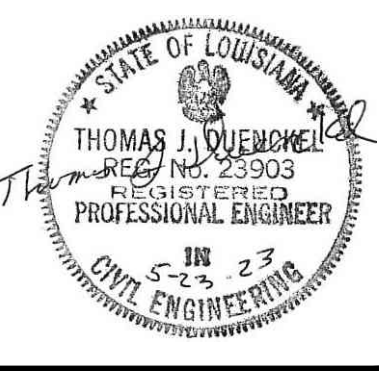

ALL SOUTH CONSULTING ENGINEERS, L.L.C.
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SOUTH LA FAIRGROUNDS
SOFTBALL BACKSTOPS REPLACEMENT
DONALDSONVILLE, LOUISIANA


FIELD #2 - PLAN AND ELEVATIONS

SHEET NO. **5**


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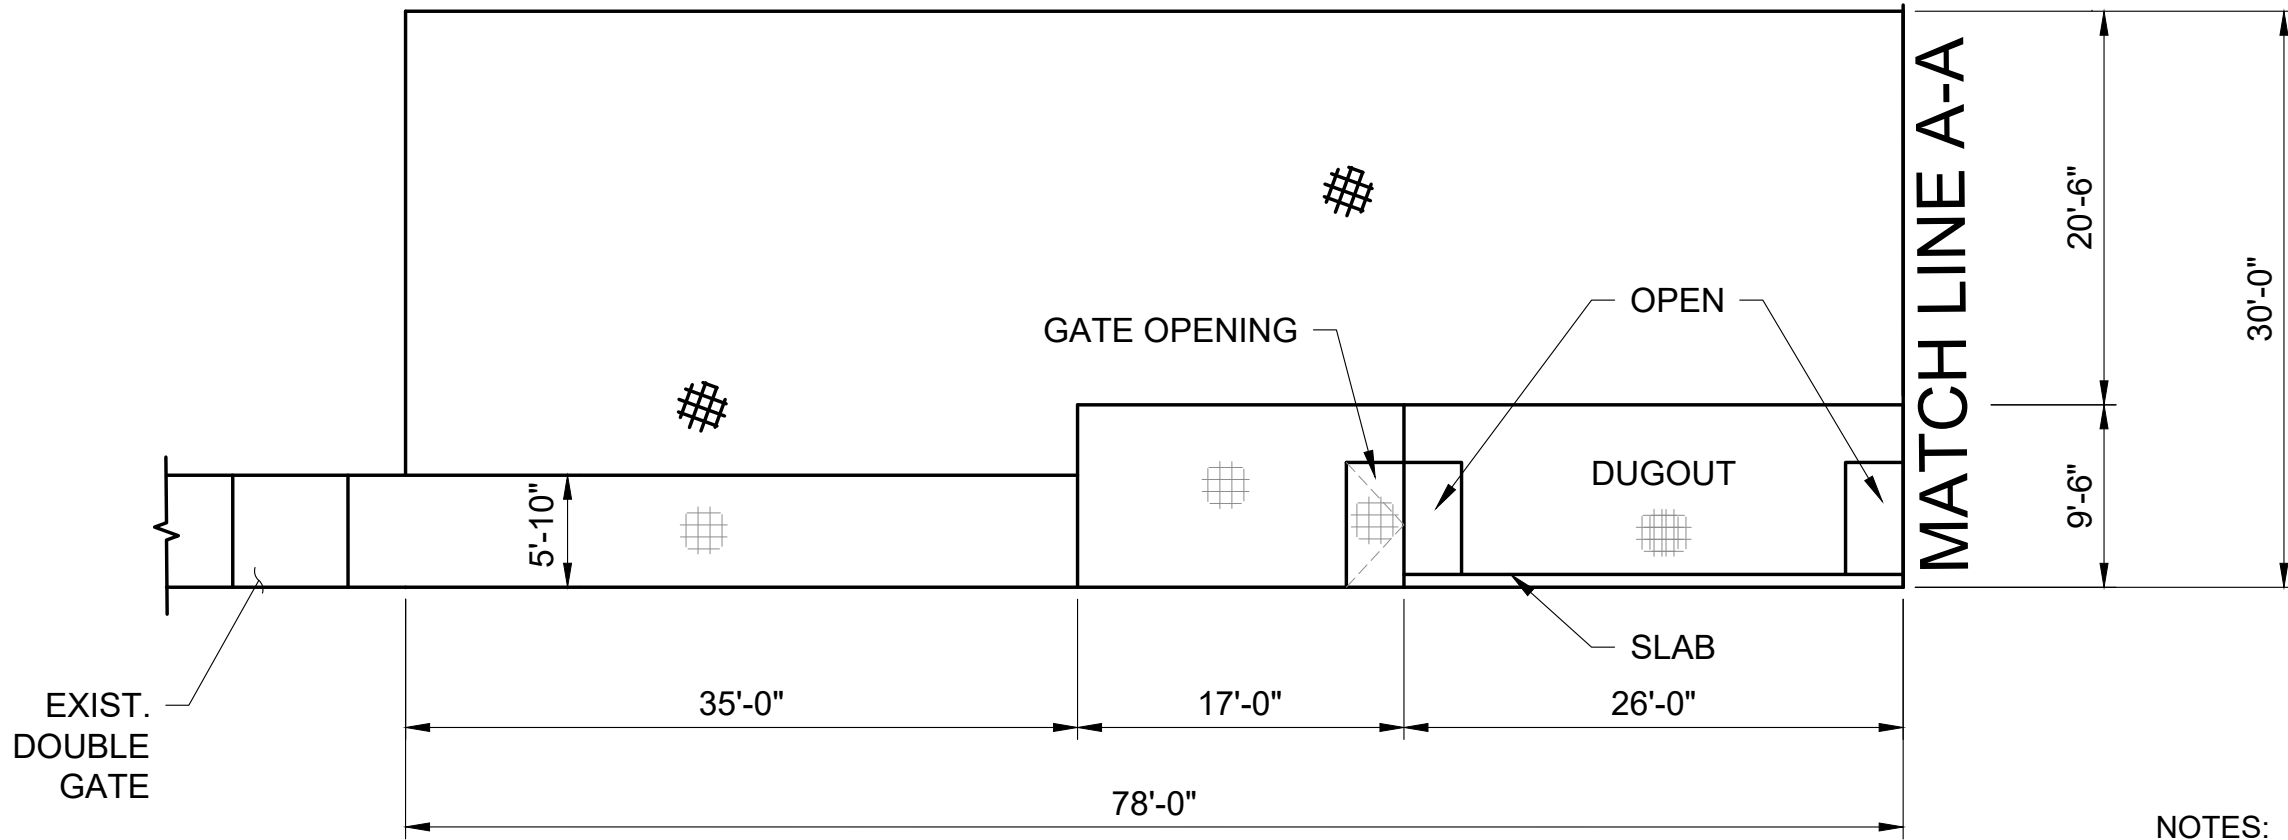
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SCALE: 1" = 20'




BACKSTOP PLAN
SCALE: 1" = 10'

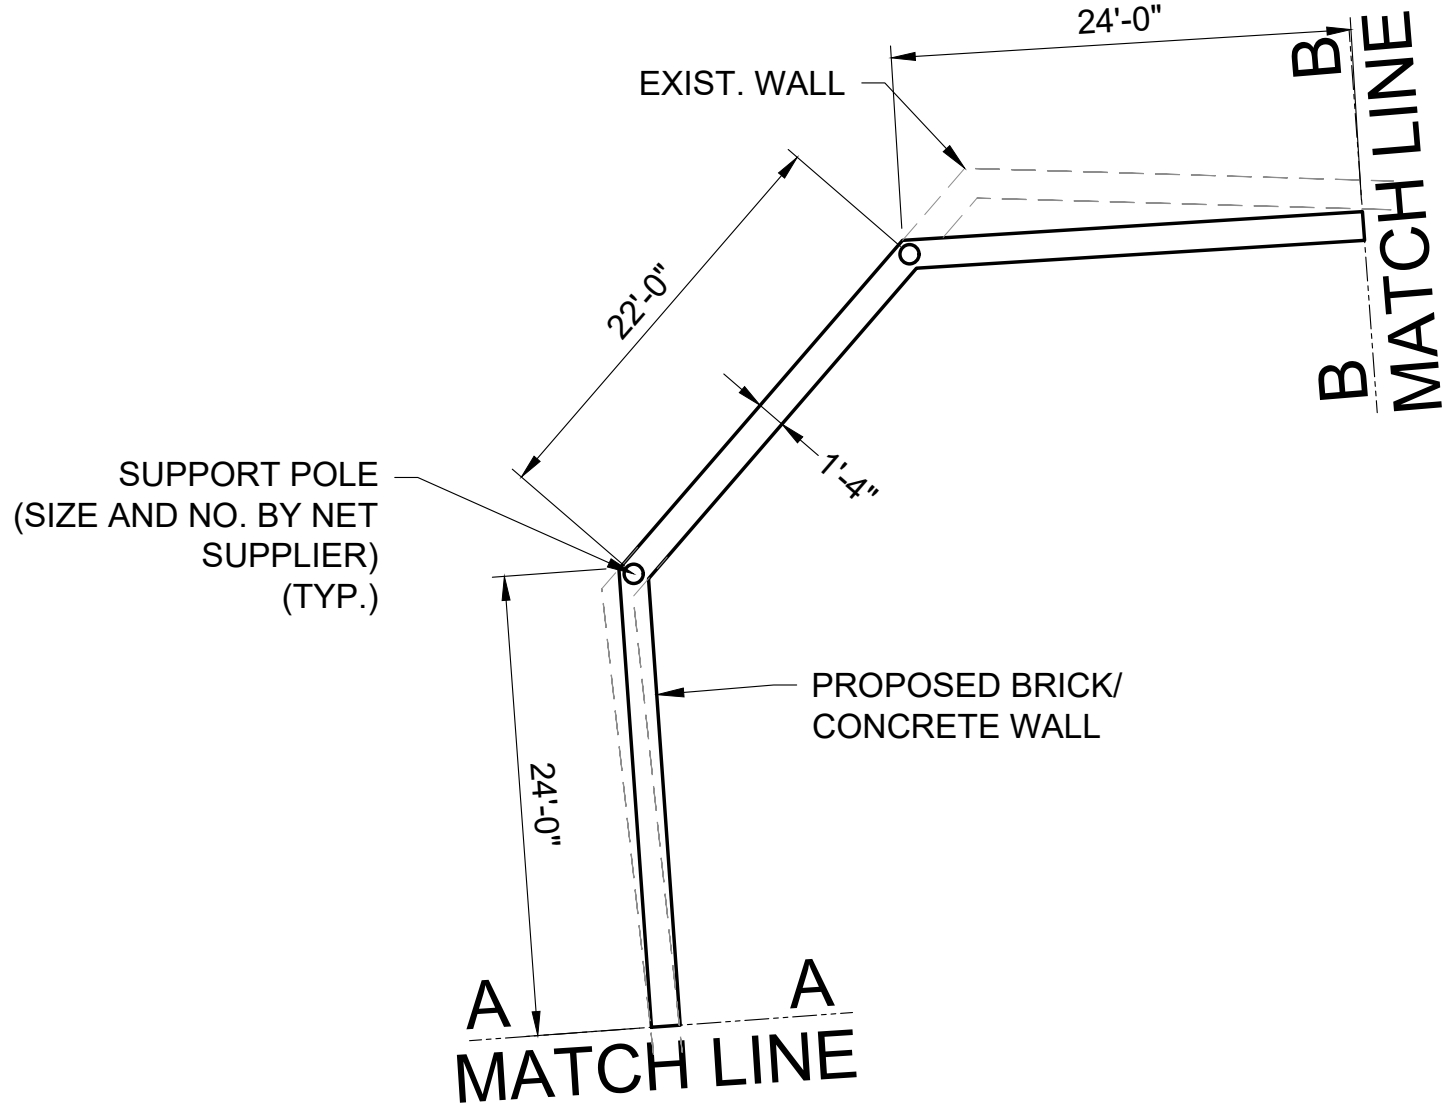

BACKSTOP ELEVATION
(WINGS SHOWN AT 90°)
SCALE: 1" = 10'

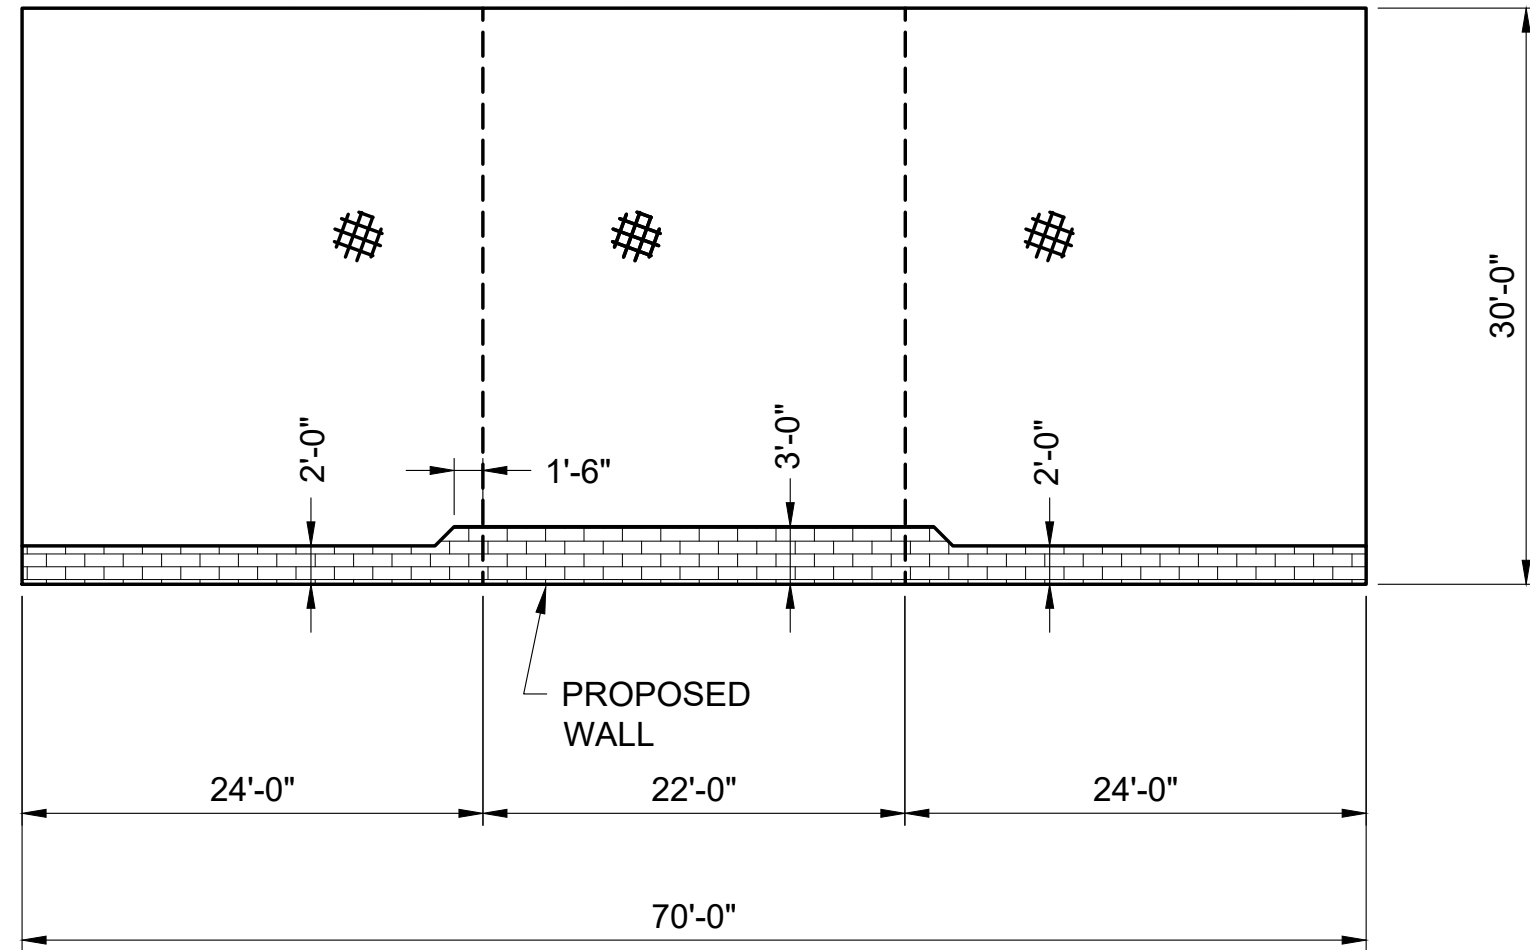

RIGHT FIELD ELEVATION
SCALE: 1" = 10'

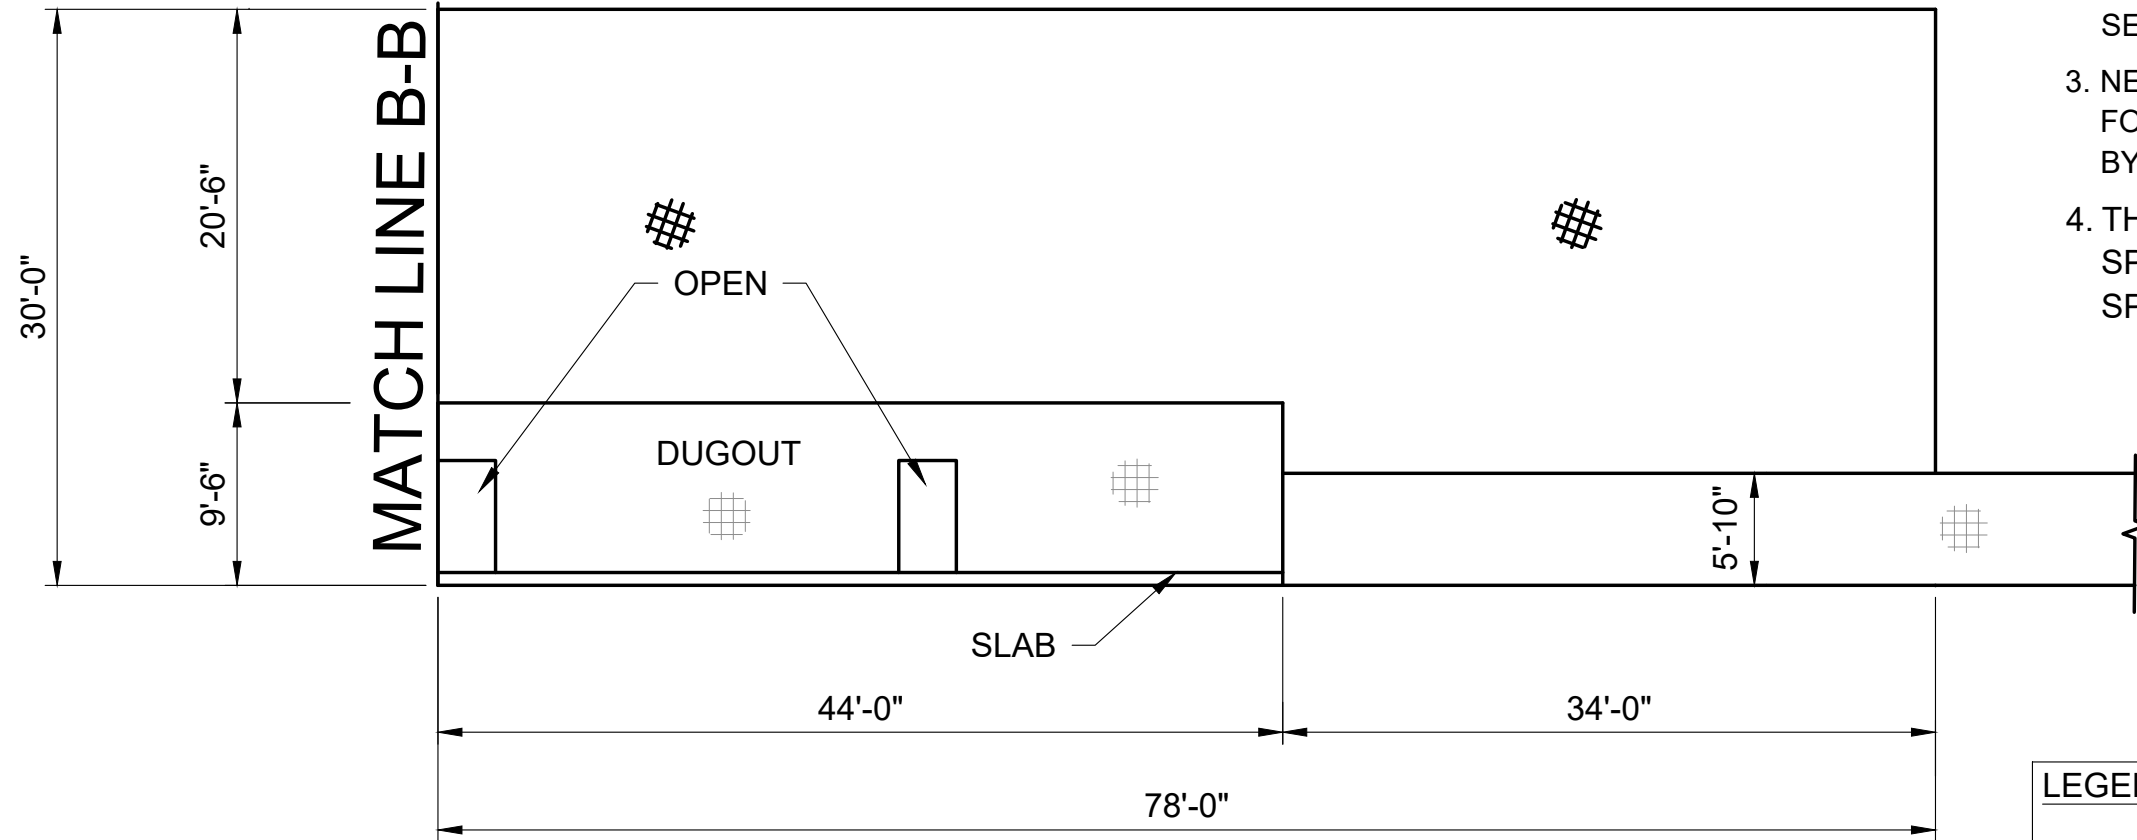


LEFT FIELD ELEVATION
SCALE: 1" = 10'

- NOTES:
1. BACKSTOP WINGS SHALL BE BUILT IN LINE WITH DUGOUT (CONTRACTOR TO LAYOUT FOR ENGINEER APPROVAL PRIOR TO CONSTRUCTION)
 2. ELEVATION DETAILS SHOW PROPOSED NETTING TERMINATING AT TOP OF EXISTING DUGOUTS, CHAINLINK FENCING, AND/OR PROPOSED WALL. SEE SHEETS 7 AND 8 FOR ATTACHMENT DETAILS.
 3. NET SUPPORT POLE LOCATIONS, SIZE, AND FOUNDATION REQUIREMENTS TO BE SPECIFIED BY NETTING SYSTEM SUPPLIER.
 4. THE BASIS OF DESIGN FOR THIS PROJECT IS SPORTSFIELD SPECIALTIES OR EQUAL. SEE SPECIFICATIONS FOR DETAILS.

LEGEND	
	CHAIN FENCE (EXIST)
	PROPOSED NETTING
	APPROXIMATE NET SUPPORT POLE LOCATION

REVISIONS	
DATE:	REMARKS:

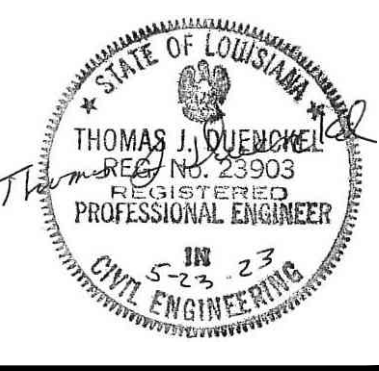

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DATE:	4/19/2023	SCALE:	AS SHOWN	JOB NO.	058-005-02

SOUTH LA FAIRGROUNDS
SOFTBALL BACKSTOPS REPLACEMENT
DONALDSONVILLE, LOUISIANA

FIELD #3 - PLAN AND ELEVATIONS

SHEET NO. 6

BACKSTOP WALL PLAN

SCALE: 1" = 2'

DETAIL A
SCALE: 1" = 1'



- NOTES:
1. WALL VARIES FROM 2'-0" - 3'-0" TALL
 2. FOR 2'-0" WALL, USE 3 CMU'S INSIDE OF WALL, MATCH FOOTING ELEVATION
 3. MAXIMUM AGGREGATE SIZE FOR CONCRETE SHALL BE $\frac{3}{4}$ "
 4. PROVIDE BRICK TIES AS REQ'D

BACKSTOP WALL SECTION
SCALE: 1" = 1'

BACKSTOP WALL ELEVATION
W/ SUPPORT POLE
SCALE: 1" = 2'

BRICK BACKSTOP WALL TRANSITION
SCALE: 1" = 1'




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DATE:	REMARKS:	

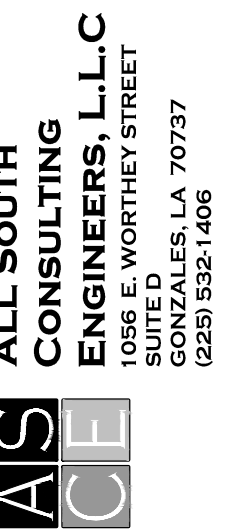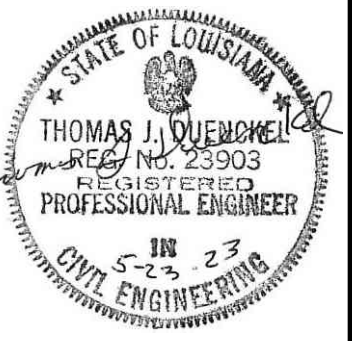

4/19/2023	TJD
SCALE: AS SHOWN	DRAWN BY: MM
JOB NO. 058-005-02	CHECKED BY: SCB

**SOUTH LA FAIRGROUNDS
SOFTBALL BACKSTOPS REPLACEMENT
DONALDSONVILLE, LOUISIANA**

BRICK BACKS UP AND WALL DETAILS

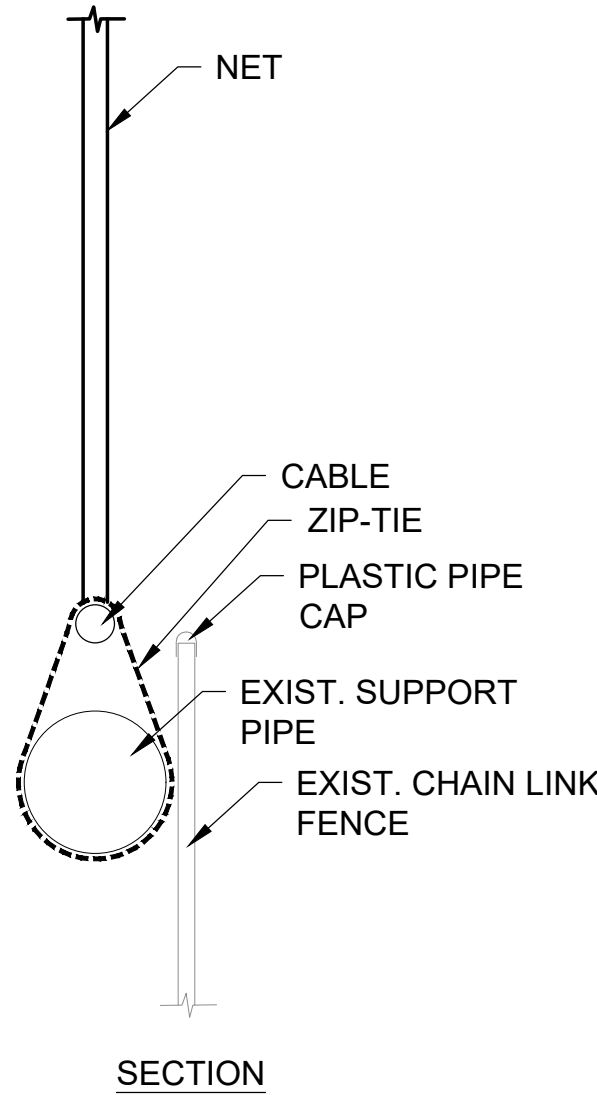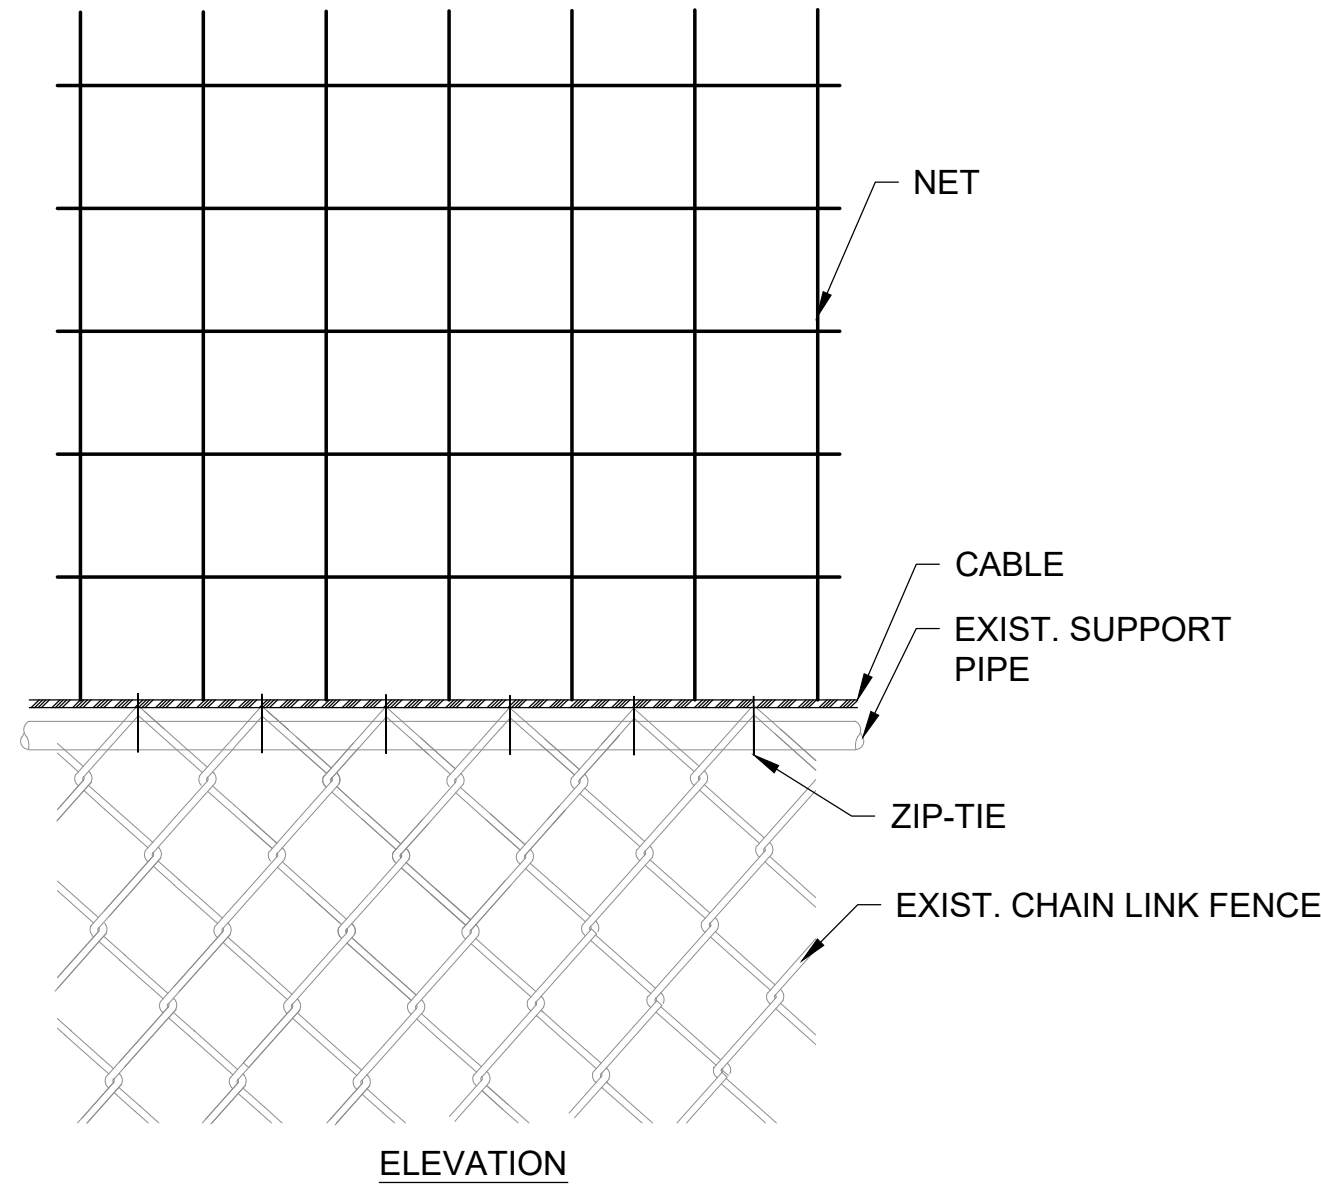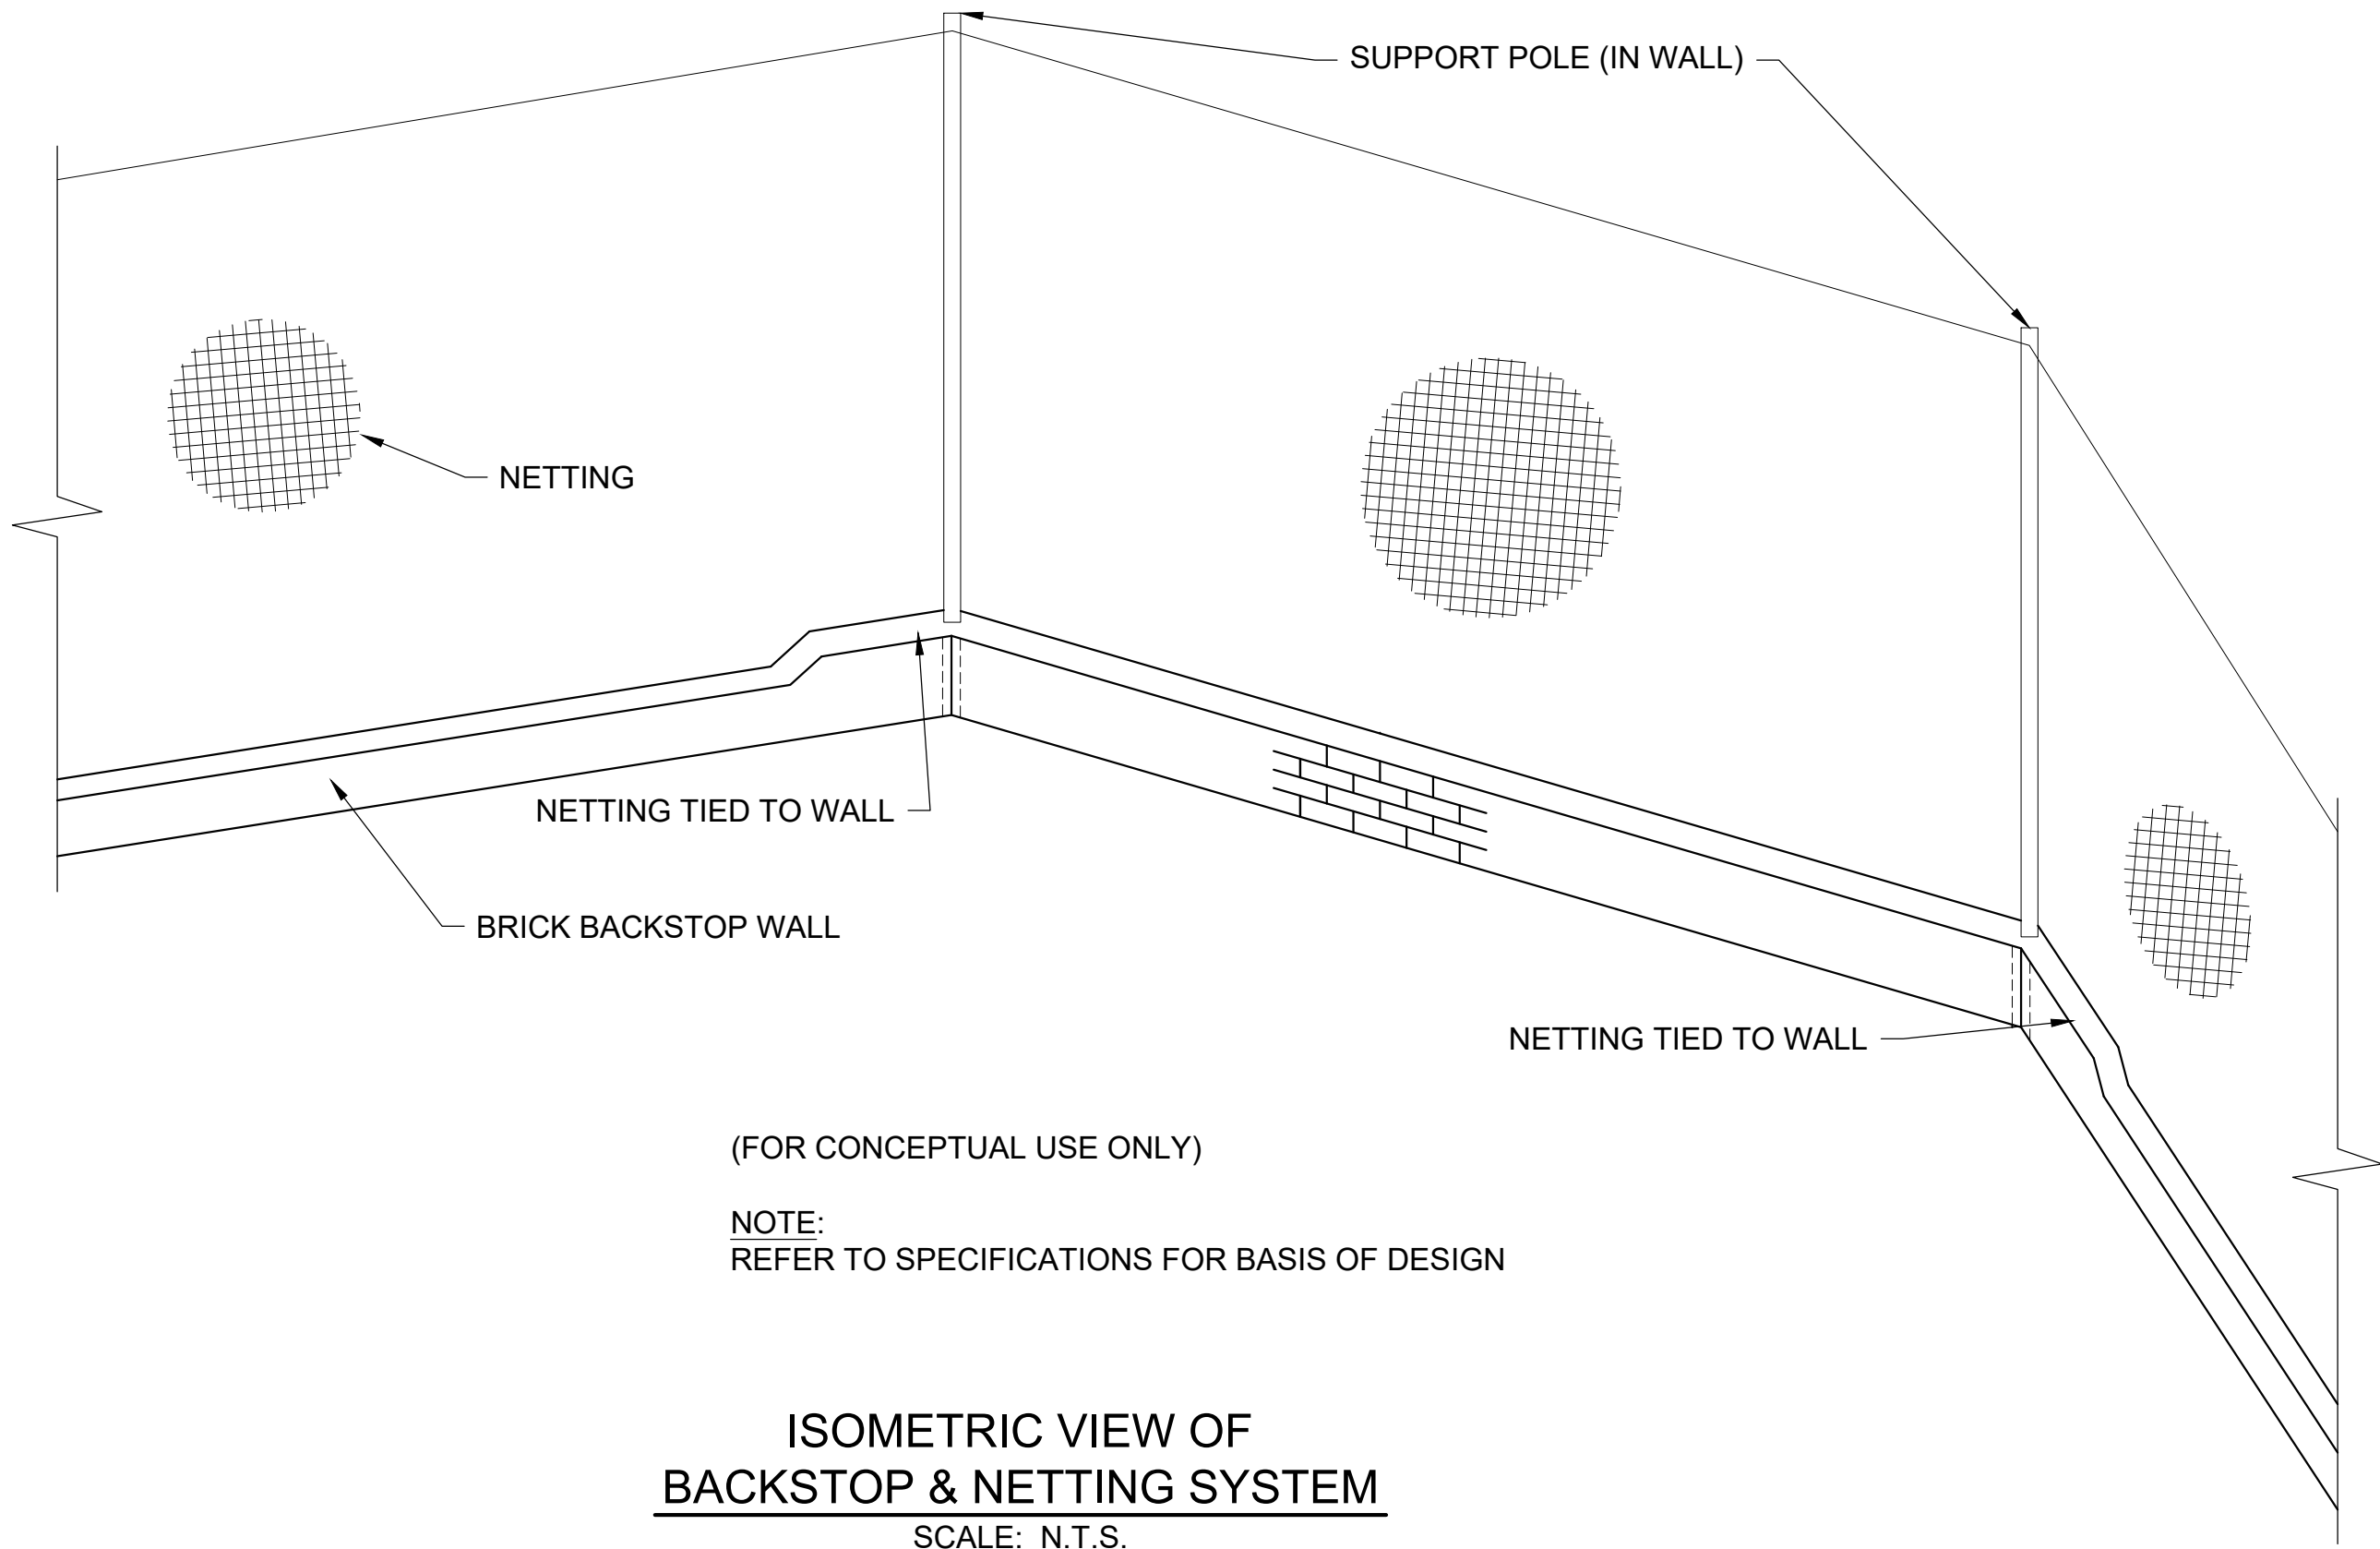

NET/FENCE TIE - IN
SCALE: N.T.S.

SOUTH LA FAIRGROUNDS
SOFTBALL BACKSTOPS REPLACEMENT
DONALDSONVILLE, LOUISIANA

SUPPORT POLE AND NETTING SYSTEM DETAILS

DATE:
4/19/2023

SCALE:
AS SHOWN

JOB NO.
058-005-02

DESIGNED BY:
TJD

DRAWN BY:
MM

CHECKED BY:
SCB

REVISIONS

DATE:REMARKS:APP'D

STATE OF LOUISIANA
THOMAS J. DOWNES
REGISTERED PROFESSIONAL ENGINEER
IN CIVIL ENGINEERING
NO. 25903
EXPIRATION DATE 12/31/2023

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ENGINEERS, L.L.C
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