

August 29, 2023

ADDENDUM NUMBER ONE

RE: Butch Gore Park Renovations

14550 Harry Savoy Road St. Amant, Louisiana 70774

The following items shall be considered part of the Contract Documents for the above referenced project and shall take precedence over any conflicting statements contained therein. Revise all other notes, schedules, details, etc. as required.

General:

1. <u>Mandatory Pre-Bid Meeting</u>

A mandatory pre-bid meeting was held at the project site on August 22, 2023, at 8:00am. A copy of the <u>pre-bid sign-in sheet and minutes of the meeting have been attached</u> for your reference.

2. Tax Exempt Status

All bidders shall bid without the sales/use tax included for purchases of component construction materials, taxable services and leases and rentals of tangible personal property (hereinafter referred to as "materials/supplies") for which they will be willing to furnish copies of invoices to Ascension Parish Government. The successful contractors and subcontractors will be named as contractor-agents of Ascension Parish Government under Louisiana R.S. 47:301(8) © in order to allow exemption of sales and use taxes for materials/supplies needed. A copy of Louisiana Department of Revenue Form R-1020 is attached for your use.

Drawings:

3. Refer to Drawing L1.1 - Geometric Layout Plan

Refer to the <u>attached revised sheet L1.1</u> for revisions to items related to additional information for pre-engineered restroom building.

4. Refer to Drawing L7.0 – Details

Refer to the <u>attached revised sheet L7.0</u> for revisions to add material schedule to sheet.





5. Refer to Drawing L7.3 – Restroom Details

Refer to the <u>attached revised sheet L7.3</u> for revisions to correct erroneous phone number listed for restroom vendor.

6. Refer to Drawing L9.0 – Irrigation Layout Plan

Refer to the <u>attached revised sheet L9.0</u> for revisions to irrigation head layout, and product data.

7. Refer to Drawing L9.1 – Irrigation Plan Enlargement

Refer to the <u>attached revised sheet L9.1</u> for revisions to irrigation head layout, and product data.

8. Refer to Drawing L9.2 – Irrigation Details

Refer to the <u>attached revised sheet L9.2</u> for revisions to irrigation valve schedule and critical analysis.

Specifications:

9. <u>Specification Section 133400 – Fabricated Engineered Structures</u>

Delete line "G" of Sub-Section 2.10 Electrical (or Accepted Substitution) which reads: "Each restroom shall receive one high speed, energy efficient, ADA compliant, vandal resistant World Slimdri hand dryer with built in automatic activation. Color to be White."

Additional Clarification and RFI Response Items:

10. Question: Is this project tax exempt?

Yes, this project will be tax exempt. See general note #2 of this addendum for additional information.

11. <u>Question: What is the engineers estimate for this project? Base, Alt 1, Alt 2, and Alt 3?</u>

The opinion of probable construction cost for the project ranges between \$1,602,000.00 for the base bid to \$2,089,000.00 for base bid and alternate no. 1 to \$1,892,000.00 for base bid and alternate no. 2 to \$1,673,000.00 for base bid and alternate no. 3.

12. Question: Who will pay for testing? Owner or contractor?

Bidders shall refer to Specification Section 014000 – Testing Laboratory Services for information and specifics related to construction and material testing.







13. Question: Clarify if the entire 3" water line/6" sewer line or just a portion be included in the alt 1 scope? There is a portion of water and sewer lines that goes under new parking and or new paved areas in base bid?

The only portion of the water line that is a part of Alternate No. 1 scope is the connection to the restroom building. The remaining water line should be priced within the base bid work. All the sanitary sewer line is a part of Alternate No. 1.

14. <u>Question: Will owner want to retain any excess excavation or broken concrete from this project?</u>

All broken concrete included within the project demolition shall be hauled off site and disposed of in a legal manner. All soil and soil-like materials shall be hauled to the Ascension Parish DPW yard at 42077 Churchpoint Road, Gonzales, LA 70737.

15. <u>Question: Clarify what parts of work that will need to be completed for the partial substantial completion deadline?</u>

The portions of the project needed to be complete for the required partial substantial completion are all the vehicular and pedestrian paving to the four fields, all synthetic turf and athletic equipment, all masonry walls and backstop netting systems, as well as associated grading, drainage, water service line, and base bid irrigation. If Bid Alternate No. 3 is awarded, that scope of work would also be required to be completed by the partial substantial completion date.

16. Question: Clarify the alternates to be bid and the products included in the specification sections and drawings related to the synthetic turf base construction?

The alternate synthetic turf base construction is a design alternate, not a bid alternate. Whichever base construction shown can be provided. It is up to the bidder to choose which method they wish to price and install.

17. <u>Question: Will the subgrade under the synthetic turf field areas be lime stabilized?</u>

Once the demolition and excavation for the field base is completed, the construction and material testing lab will take a sample of the subgrade to determine if lime stabilization is required.

18. <u>Question: Is an overflow outlet included for the Permavoid attenuation units</u> of the Alternate Base Construction for the synthetic turf fields?

All recommended components by the manufacturer are to be provided for the alternate base construction for the synthetic turf fields.





19. <u>Question</u>: Is a protective geotextile such as an 8-ounce per square yard nonwoven fabric included under the 20 mil PVC liner of the Alternate Base Construction for the synthetic turf fields?

For the alternate base construction for the synthetic turf fields, bidders shall price all materials recommended by the manufacturer of that system.

Prior Approval Items:

- 20. Specification Section 321823 Infilled Synthetic Turf
 - Synthetic Turf
 - o Edge XPL by Sportsgrass is a prior approved manufacturer.
 - Edge XP by Sportsgrass is a prior approved manufacturer.
 - XtremeTurf DXF50 by ACTGlobal is a prior approved manufacturer.

End of Addendum No. 1



St. Amant, Louisiana 70774 14550 Harry Savoy Road QES Project No. 23-055

Pre-Bid Conference Date: Tuesday, August 22, 2023 @ 8:00am

	Traylor (a) GUESLA. com	225-698-1600	QEX	ATA SAMAIL
	INDETTIGO OBLA COM	225.650.1600	QES	MICHAEL BYTH
	pridad his paperus	225-364-1344	406	Midwell Vi y
28/8h	Cyach Sheunite, con	1)5-767-2926	Down to (ansy	(35 Cy C 705/2
	bids @ kelly construction group. Com	225-243-4949	Kelly Construction Group	Cohen Nix
42839	bid @ mclin construction. com	225-435-3004	M'Lin Construction	Steve McLin
	K. perry@geosuctuces.com	225 721-3366	Geo Surfaces	Latherice Parry
34263	pidding a) la cont com	-	Ur Cand withing tent use 955 196-2212	Brent Kolongu
	lear-behr (asports edge, com	,	Sports Edge	Leon Rehr
02020	Jones Countration Solutions 225-348-340 Bids @ JCSBuilds. Com	5 225-348-340	Jones Countration Solution	Calob Some;
	STEMMA CONSTRUCTION 225-456-5466 B. DS@S. CLAMA CONSTRUCTION NET	225-456-5466 !	STEMMA CONSTRUCTION	Lawtonwapener
	Radael. Farrai & aprov. US	225-8953-7707	ASCOUSION PARISH	Kachael Facini
	Kipere actalobal. com	985-400-4775	Act Global	Laura Kiper
65087	daniel @ ats-la.com	(337)526-7712	Athletic Test Solutions, LLC (337)526-7712	Daniel Veuleman
43536	PAOLO @ANR-CONSTRUCTION. COM 43536		ANR OUNSTRUCTION (11) (225) 434.2616	JEFF TRA
	Kyle adanhames GC @ gmail com	377-580-819	Aden Homes	Ryle Suite
	Brandon, golson @/mail. Com	225-229-0490	Peak	Trandon Galson
Contractor License No.:	Email:	Phone:	Company:) Name:

Name:	Company:	Phone:	Email:	Contractor License No.:
Devin Russ	Roussian Pavisn	[P11 -084 (525)	devin nus passonus	
Geoff Sanders Ascentin Parish	Ascensius Parish	850-380-324	850-380-3249 geoff. Sanders @ apgov. us	S



August 28, 2023

Butch Gore Park Renovations Pre-Bid Meeting Minutes Project Site – 8:00am

Attendees:

Ascension Parish Government: Rachael Farrar, Michael King, Devin Russ, Geoff Sanders
Quality Engineering & Surveying, LLC: Michael Petty, Thomas Taylor
Refer to attached sign-in sheet for other attendees.

MEETING MINUTES:

- Michael Petty (Quality Engineering & Surveying) introduces himself and the representatives present from Ascension Parish Government, and Quality Engineering & Surveying (see sign-in sheet attachment).
- Michael Petty reminds all in attendance that today's meeting is a mandatory pre-bid meeting for the subject project and requires everyone to sign in on the circulated sign-in sheet (see attachment).
- Michael Petty details the scope of work for the project:
 - The base bid consists of the replacement of four (4) infields, backstops, partial irrigation, concrete paving, accessible parking, as well as drainage improvements.
 - The project includes a total of three (3) bid alternates including a pre-engineered restroom with associated utilities, a walking trail, as well as outfield irrigation.
- Michael Petty discussed the project schedule with the following specifics:
 - The contractor duration was discussed to be 150 calendar days from the Notice to Proceed.
 - The partial substantial completion date for the playing field scope items will be February 29th, 2024.
- Michael Petty stated the first bid addendum is expected to be issued early during the week of August 28th.
- Michael Petty discussed that all potential bidders should perform any site inspections at the pre-bid meeting.
- Several questions were asked during the pre-bid meeting by potential bidders. These questions are documented within Bid Addendum No. 1.

Minutes Prepared By: Michael L. Petty, PLA, CLARB Quality Engineering & Surveying, LLC





Designation of Construction Contractor as Agent of a Governmental Entity Sales Tax Exemption Certificate


		, an agency of the officed
Legal Name of Governmental Entity	of the Otata of I	
States government, or an agency, board, commission, or instrumentality	of the State of L	ouisiana or its political subdivisions, including
parishes, municipalities and school boards, does hereby designate the fo	ollowing contracto	or as its agent for the purpose of making sales
tax exempt purchases on behalf of the governmental body:		
Name of Contractor		
Address		
City	State	ZIP
This designation of agency shall be effective for purchases of component of tangible personal property for the following named construction projec		erials, taxable services and leases and rentals
Construction Project		Contract Number
This designation and acceptance of agency is effective for the period		
Beginning Date (mm/dd/yyyy) End	Date (mm/dd/yyyy)	
Purchases for the named project during this period by the designated con	tractor shall be co	onsidered as the legal equivalent of purchases


directly by the governmental body. Any materials purchased by this agent shall immediately, upon the vendor's delivery to the agent, become the property of this government entity. This government entity, as principal, assumes direct liability to the vendor for the payment of any property, services, leases, or rentals made by this designated agent. This agreement does not void or supersede the obligations of any party created under any construction contract related to this project, including specifically any contractual obligation of the construction contractor to submit payment to the vendors of materials or services for the project.


This contractor-agent is not authorized to delegate this purchasing agency to others; separate designations of agency by this governmental entity are required for each contractor or sub-contractor who is to purchase on behalf of this governmental entity. The undersigned hereby certify that this designation is the entirety of the agency designation agreement between them. In order for a purchase for an eligible governmental entity through a designated agent to be eligible for sales tax exemption, the designation of agency must be made, accepted, and disclosed to the vendor before or at the time of the purchase transaction.

Designation of Agency			Acceptance of Agency			
Signature of Authorized Designator		Date (mm/dd/yyyy)	Signature of Contractor or Subcontractor Authorized	Acceptor	Date (mm/dd/yyyy)	
Name of Authorized Designator			Name of Contractor's or Subcontractor's Acceptor			
Name of Governmental Entity			Name of Contractor			
Address			Address			
City	State	ZIP	City	State	ZIP	

This designation of agency form, when properly executed by both the contractor and the governmental entity, shall serve as evidence of the sales tax exempt status that has been conferred onto the contractor. No other exemption certificate form is necessary to claim exemption from sales taxes. The agency agreement evidenced by this sales tax exemption certificate must be implemented at the time of contract execution with the governmental entity. The contract between the governmental entity and his agent must contain provisions to authenticate the conferment of agency.

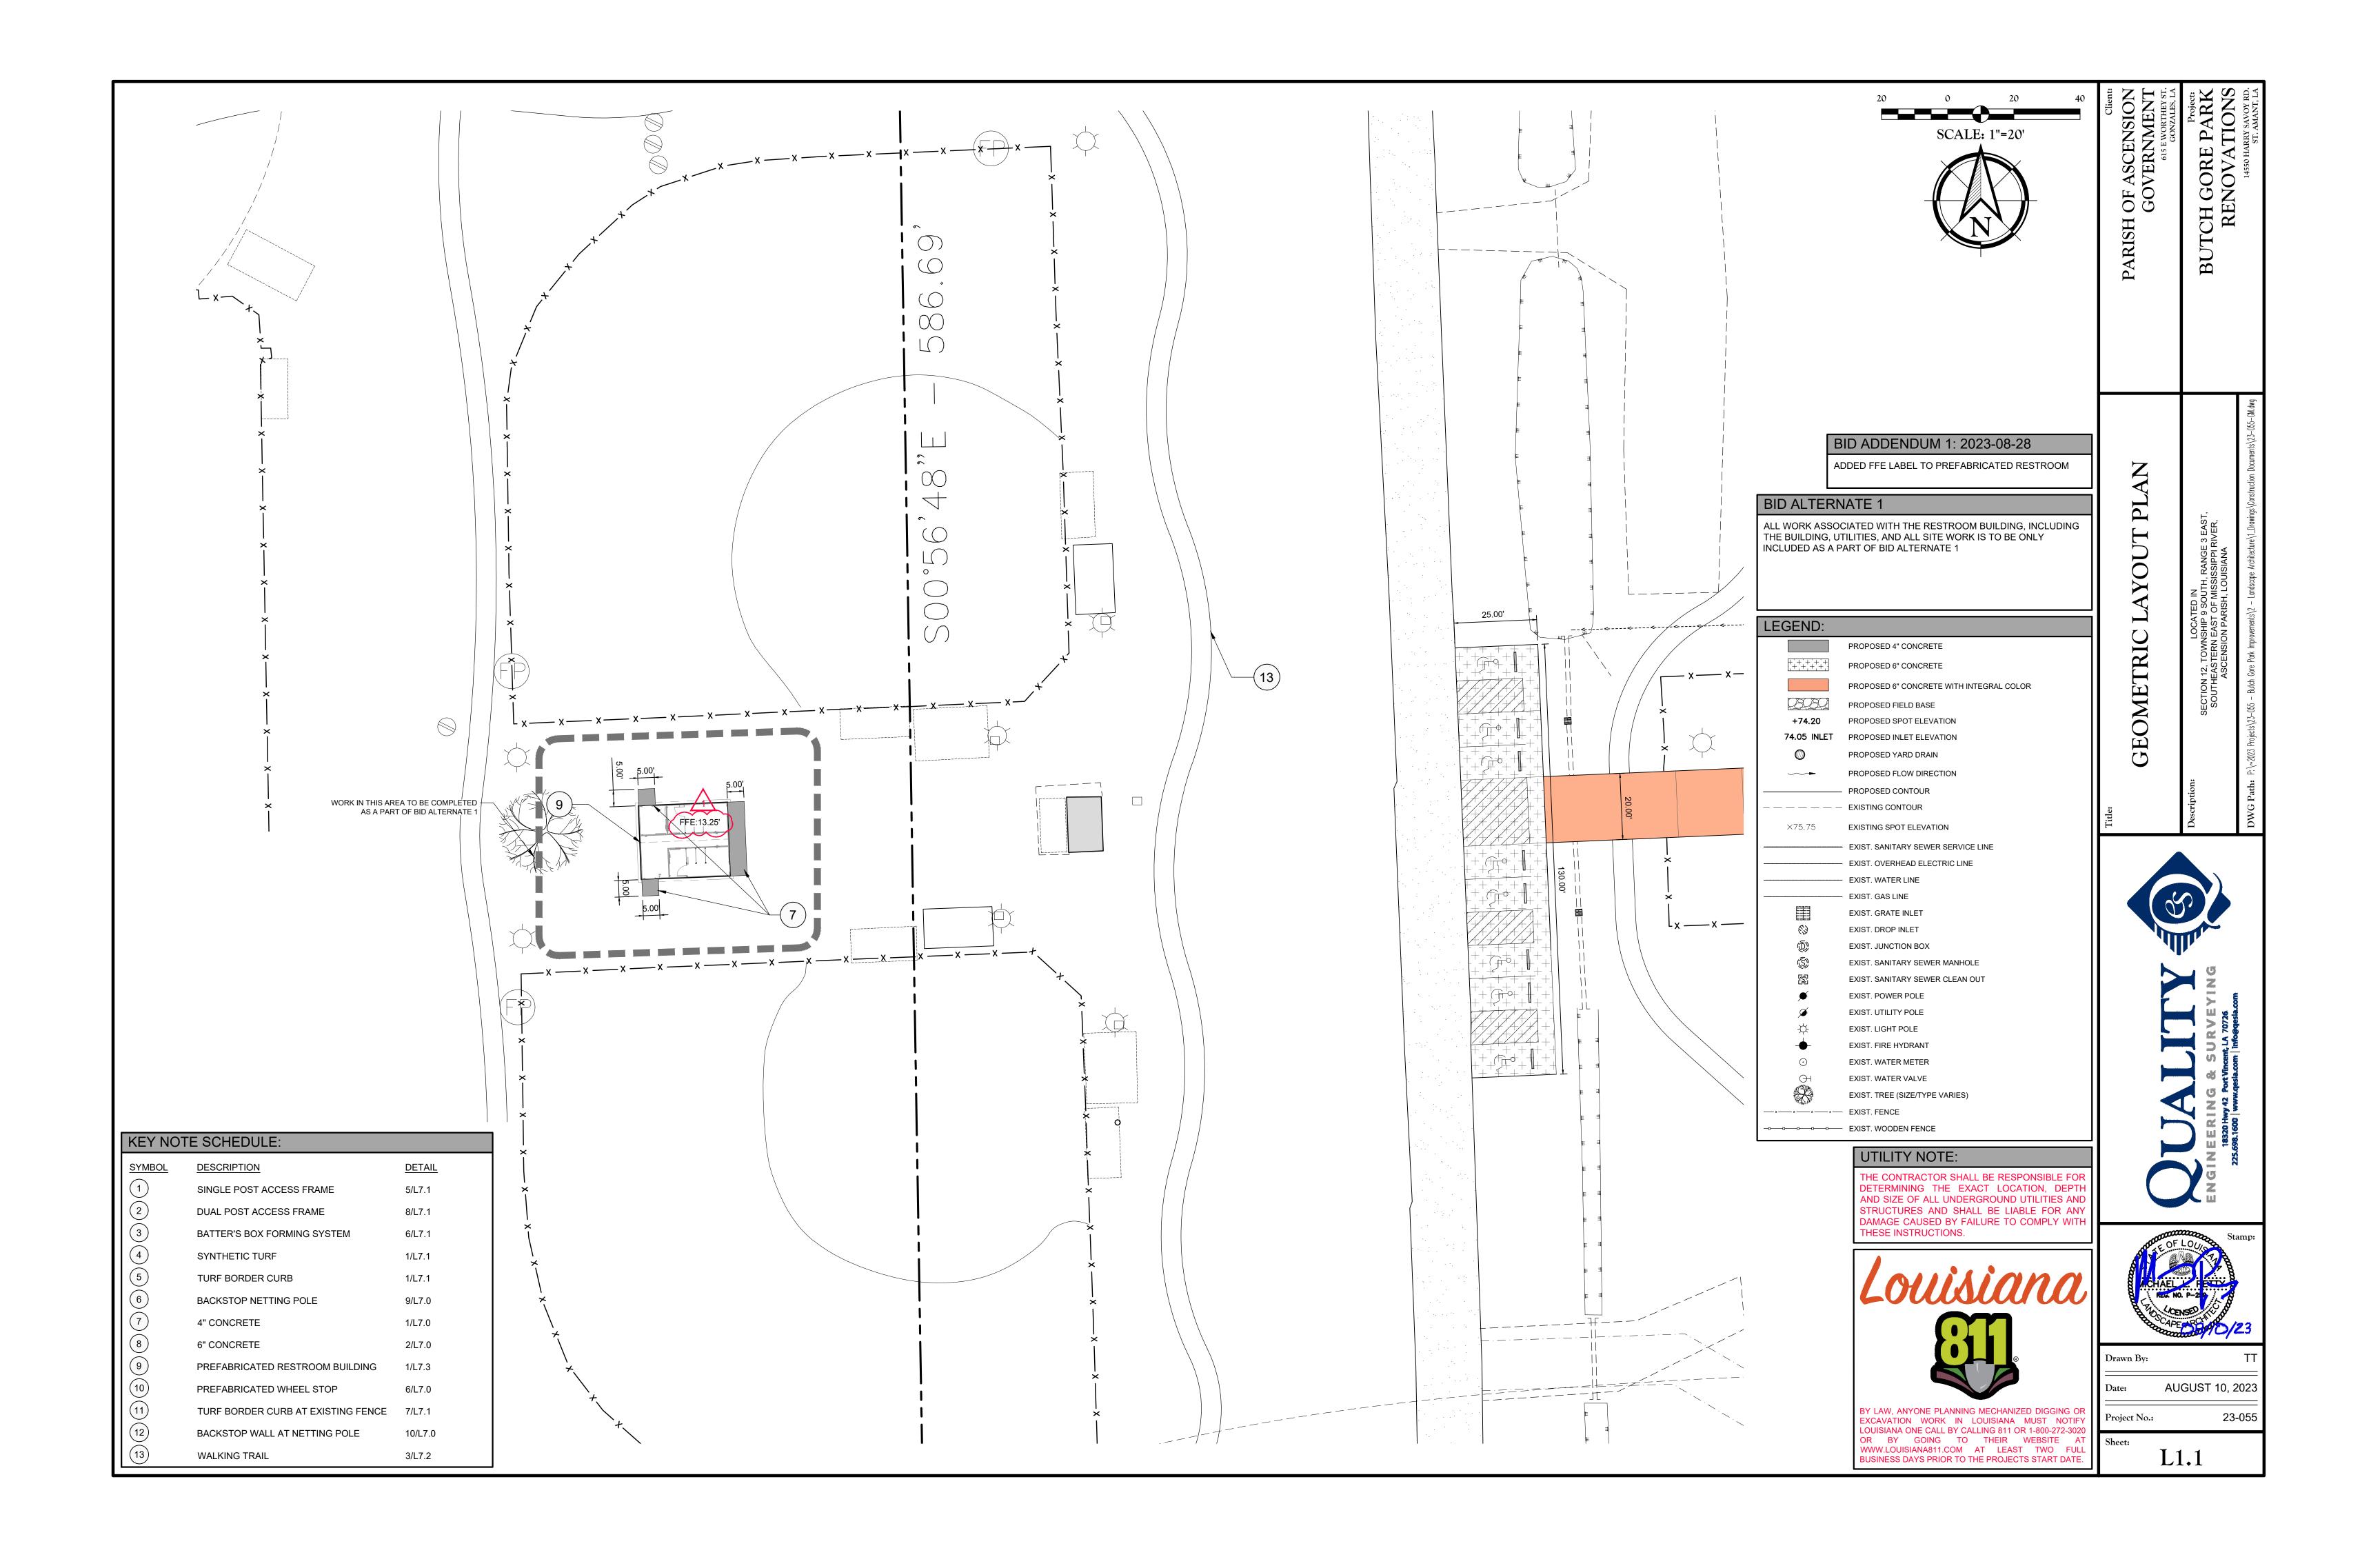

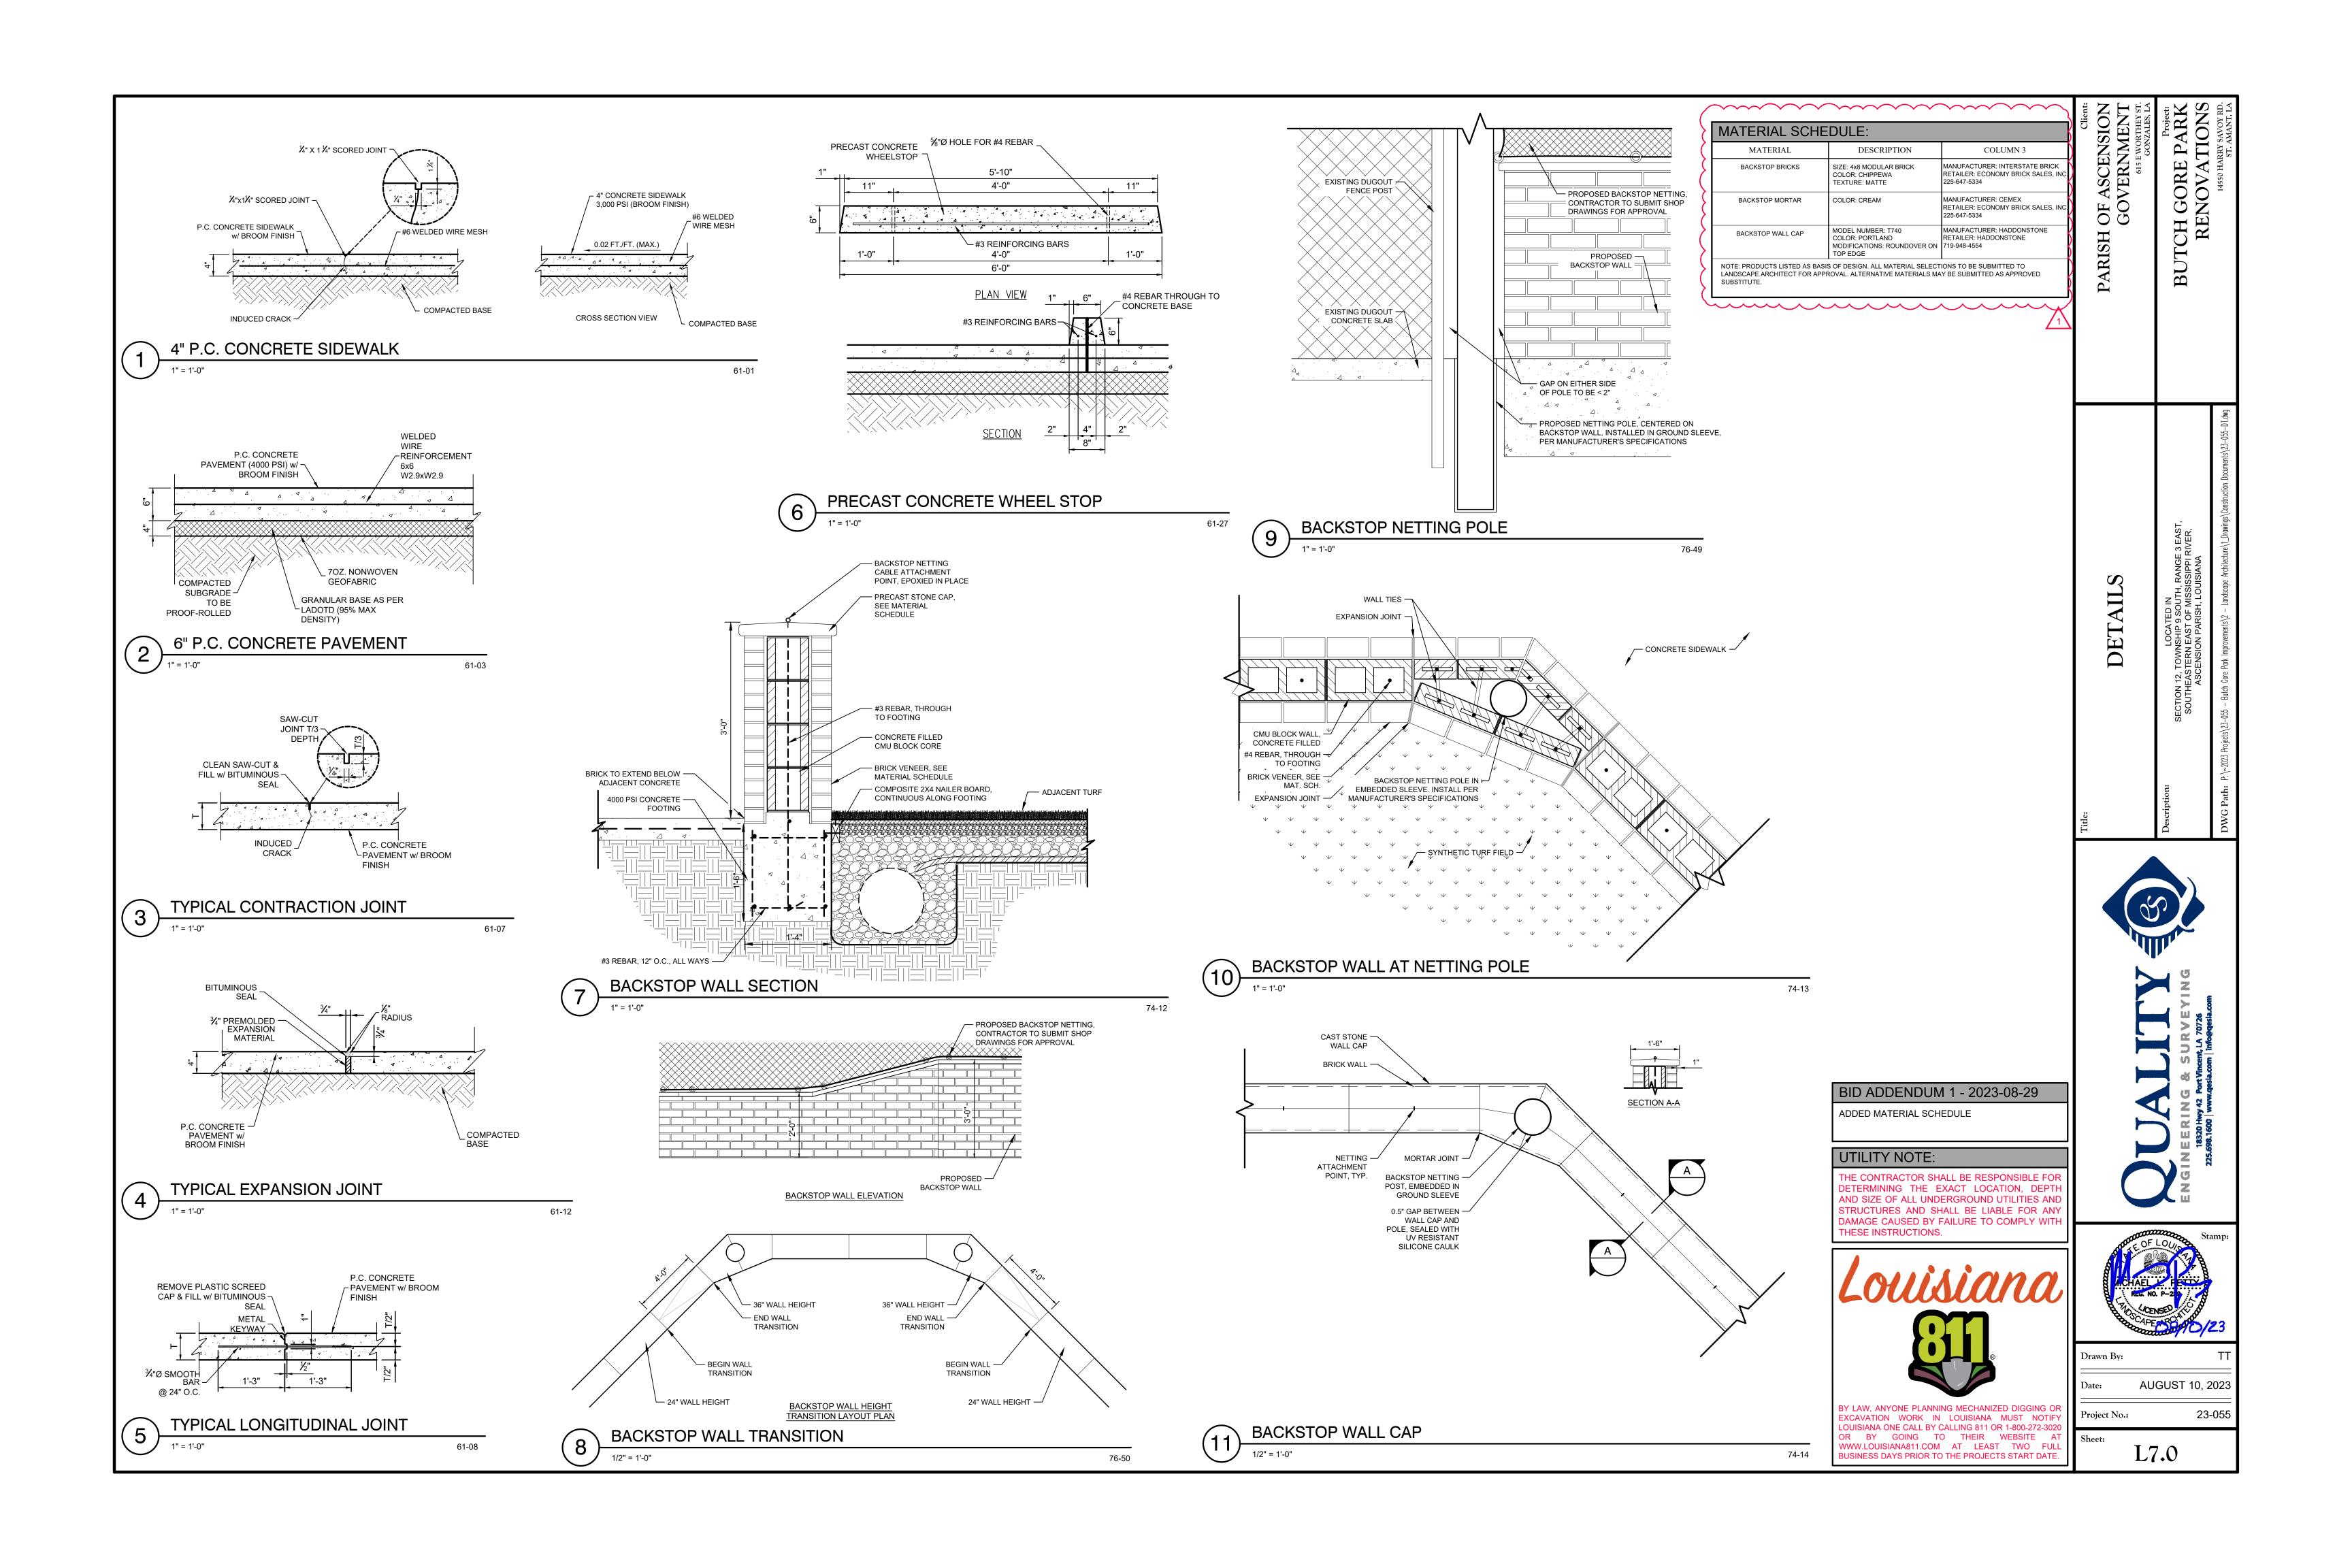

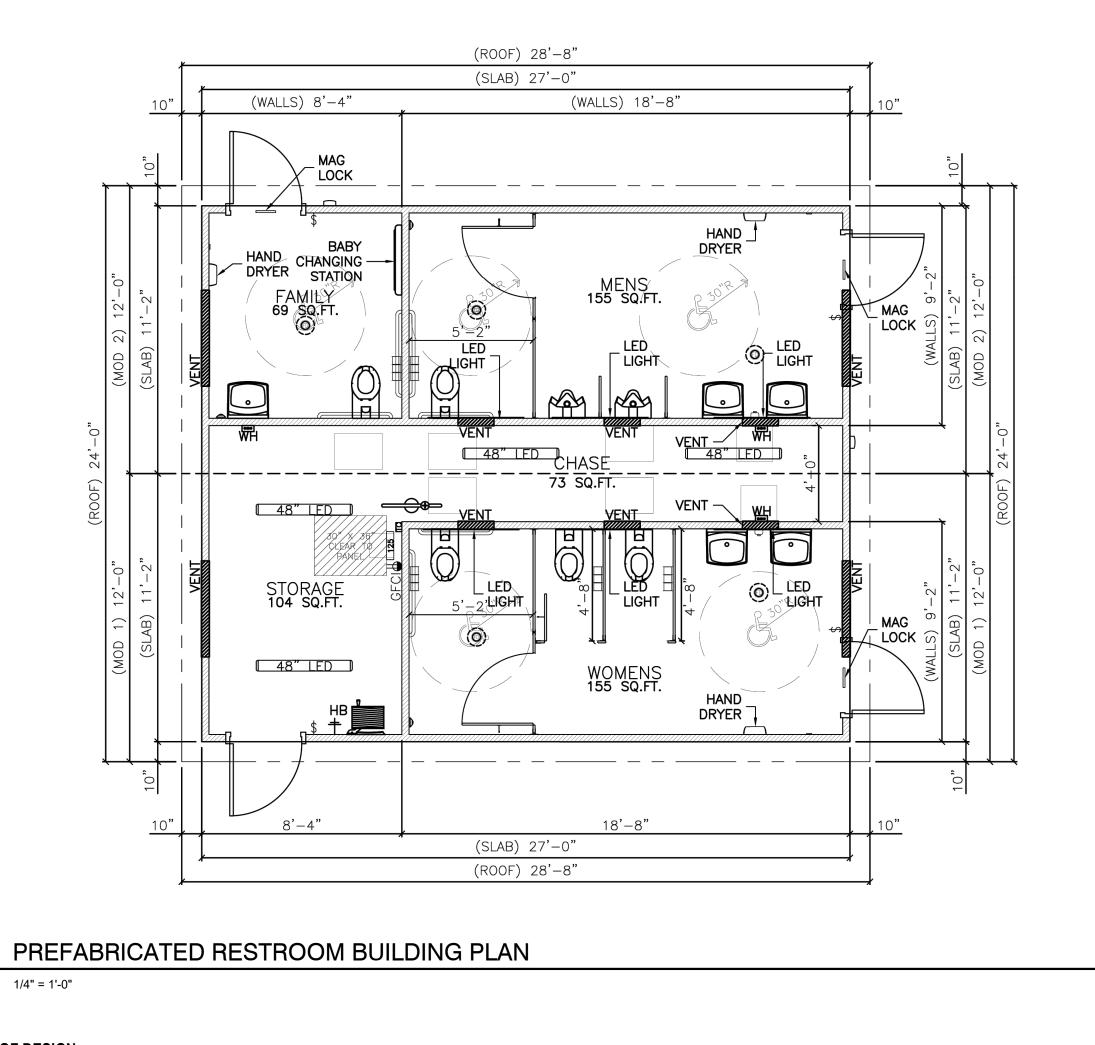

_ LED LIGHT STANDING SEAM METAL ROOF SPLIT FACE CMU — RESTROOM NORTH ELEVATION VIEW-962687016 STANDING SEAM METAL ROOF - SPLIT FACE CMU RESTROOM SOUTH ELEVATION

BASIS OF DESIGN

PRODUCT:


CORWORTH RESTROOM FACILITIES

PRODUCT NUMBER: B525ST ~~~~~

CONTACT:

BRIAN CRAFT 1-512-222-5454 WWW.CORWORTH.COM

- INSTALL PER MANUFACTURER'S INSTRUCTIONS.
- CONTRACTOR SHALL PROVIDE STAMPED SHOP DRAWINGS FOR REVIEW AND APPROVAL BY LANDSCAPE ARCHITECT.
- ACCEPTED SUBSTITUTE.
- CONTRACTOR MAY SUBMIT ALTERNATIVE VENDORS TO BE CONSIDERED AS

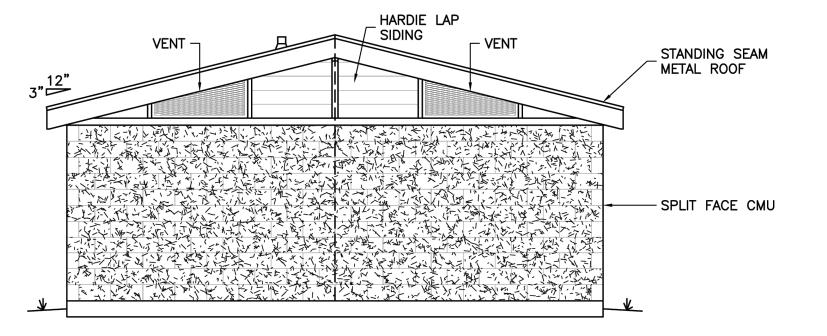


VIEW-446638227

VIEW-150183261

RESTROOM WEST ELEVATION

VIEW-775563300

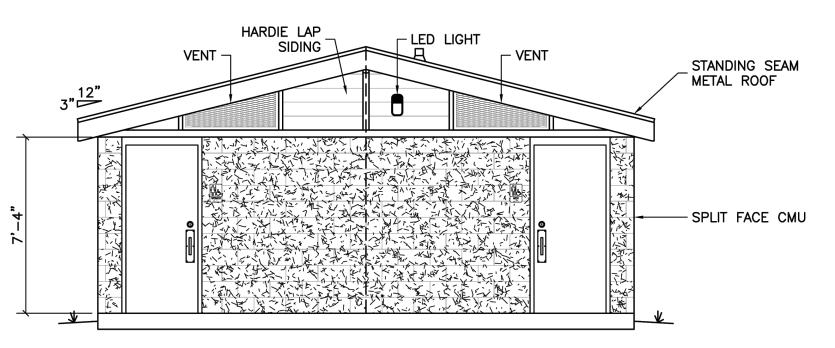

RESTROOM EAST ELEVATION

DETAILS ON THIS SHEET ARE SHOWN FOR ILLUSTRATIVE CONCEPT PURPOSES TO SHOW REQUIRED FEATURES OF THE FINAL PRODUCT ONLY. CONTRACTOR TO PROVIDE SHOP DRAWINGS FOR RESTROOM FACILITY STAMPED BY LOUISIANA LICENSED ARCHITECT OR ENGINEER.

UTILITY NOTE:


NOTE:

VIEW-186378658

BID ADDENDUM 1 - 2023-08-28

CORRECTED CONTACT INFORMATION

THE CONTRACTOR SHALL BE RESPONSIBLE FOR DETERMINING THE EXACT LOCATION, DEPTH AND SIZE OF ALL UNDERGROUND UTILITIES AND STRUCTURES AND SHALL BE LIABLE FOR ANY DAMAGE CAUSED BY FAILURE TO COMPLY WITH THESE INSTRUCTIONS.

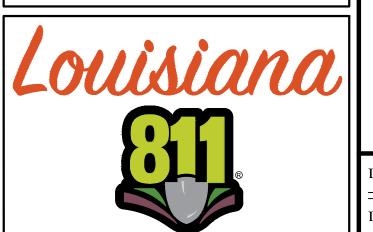


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DETAIL





Drawn By: AUGUST 10, 2023

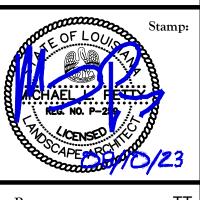23-055

L7.3


Project No.:


NOTES:


- 1) PREFABRICATED RESTROOM FACILITY TO BE CONSTRUCTED ONLY AS A PART OF BID ALTERNATE 1 2) BUILDING TO BE CONSTRUCTED OFFSITE AND CRANED INTO PLACE.
- 3) MINIMUM 10" OF NATIVE SOIL & ORGANICS TO BE REMOVED FROM RESTROOM SITE.
- 4) CONTRACTOR TO CONSTRUCT BUILDING PAD TO 95% COMPACTION. 5) CONTRACTOR SHALL BRING WATER AND ELECTRIC CONNECTIONS WITHIN 5' OF RESTROOM BUILDING PAD PRIOR TO RESTROOM DELIVERY. 6) ON DELIVERY OF RESTROOM, CONTRACTOR TO MAKE FINAL UTILITY

CONNECTIONS TO FACILITY PRIOR TO RESTROOM BUILDING VENDOR

RESTROOM BUILDING TO HAVE AN 8" REINFORCED CONCRETE SLAB ATTACHED TO BUILDING ON ARRIVAL

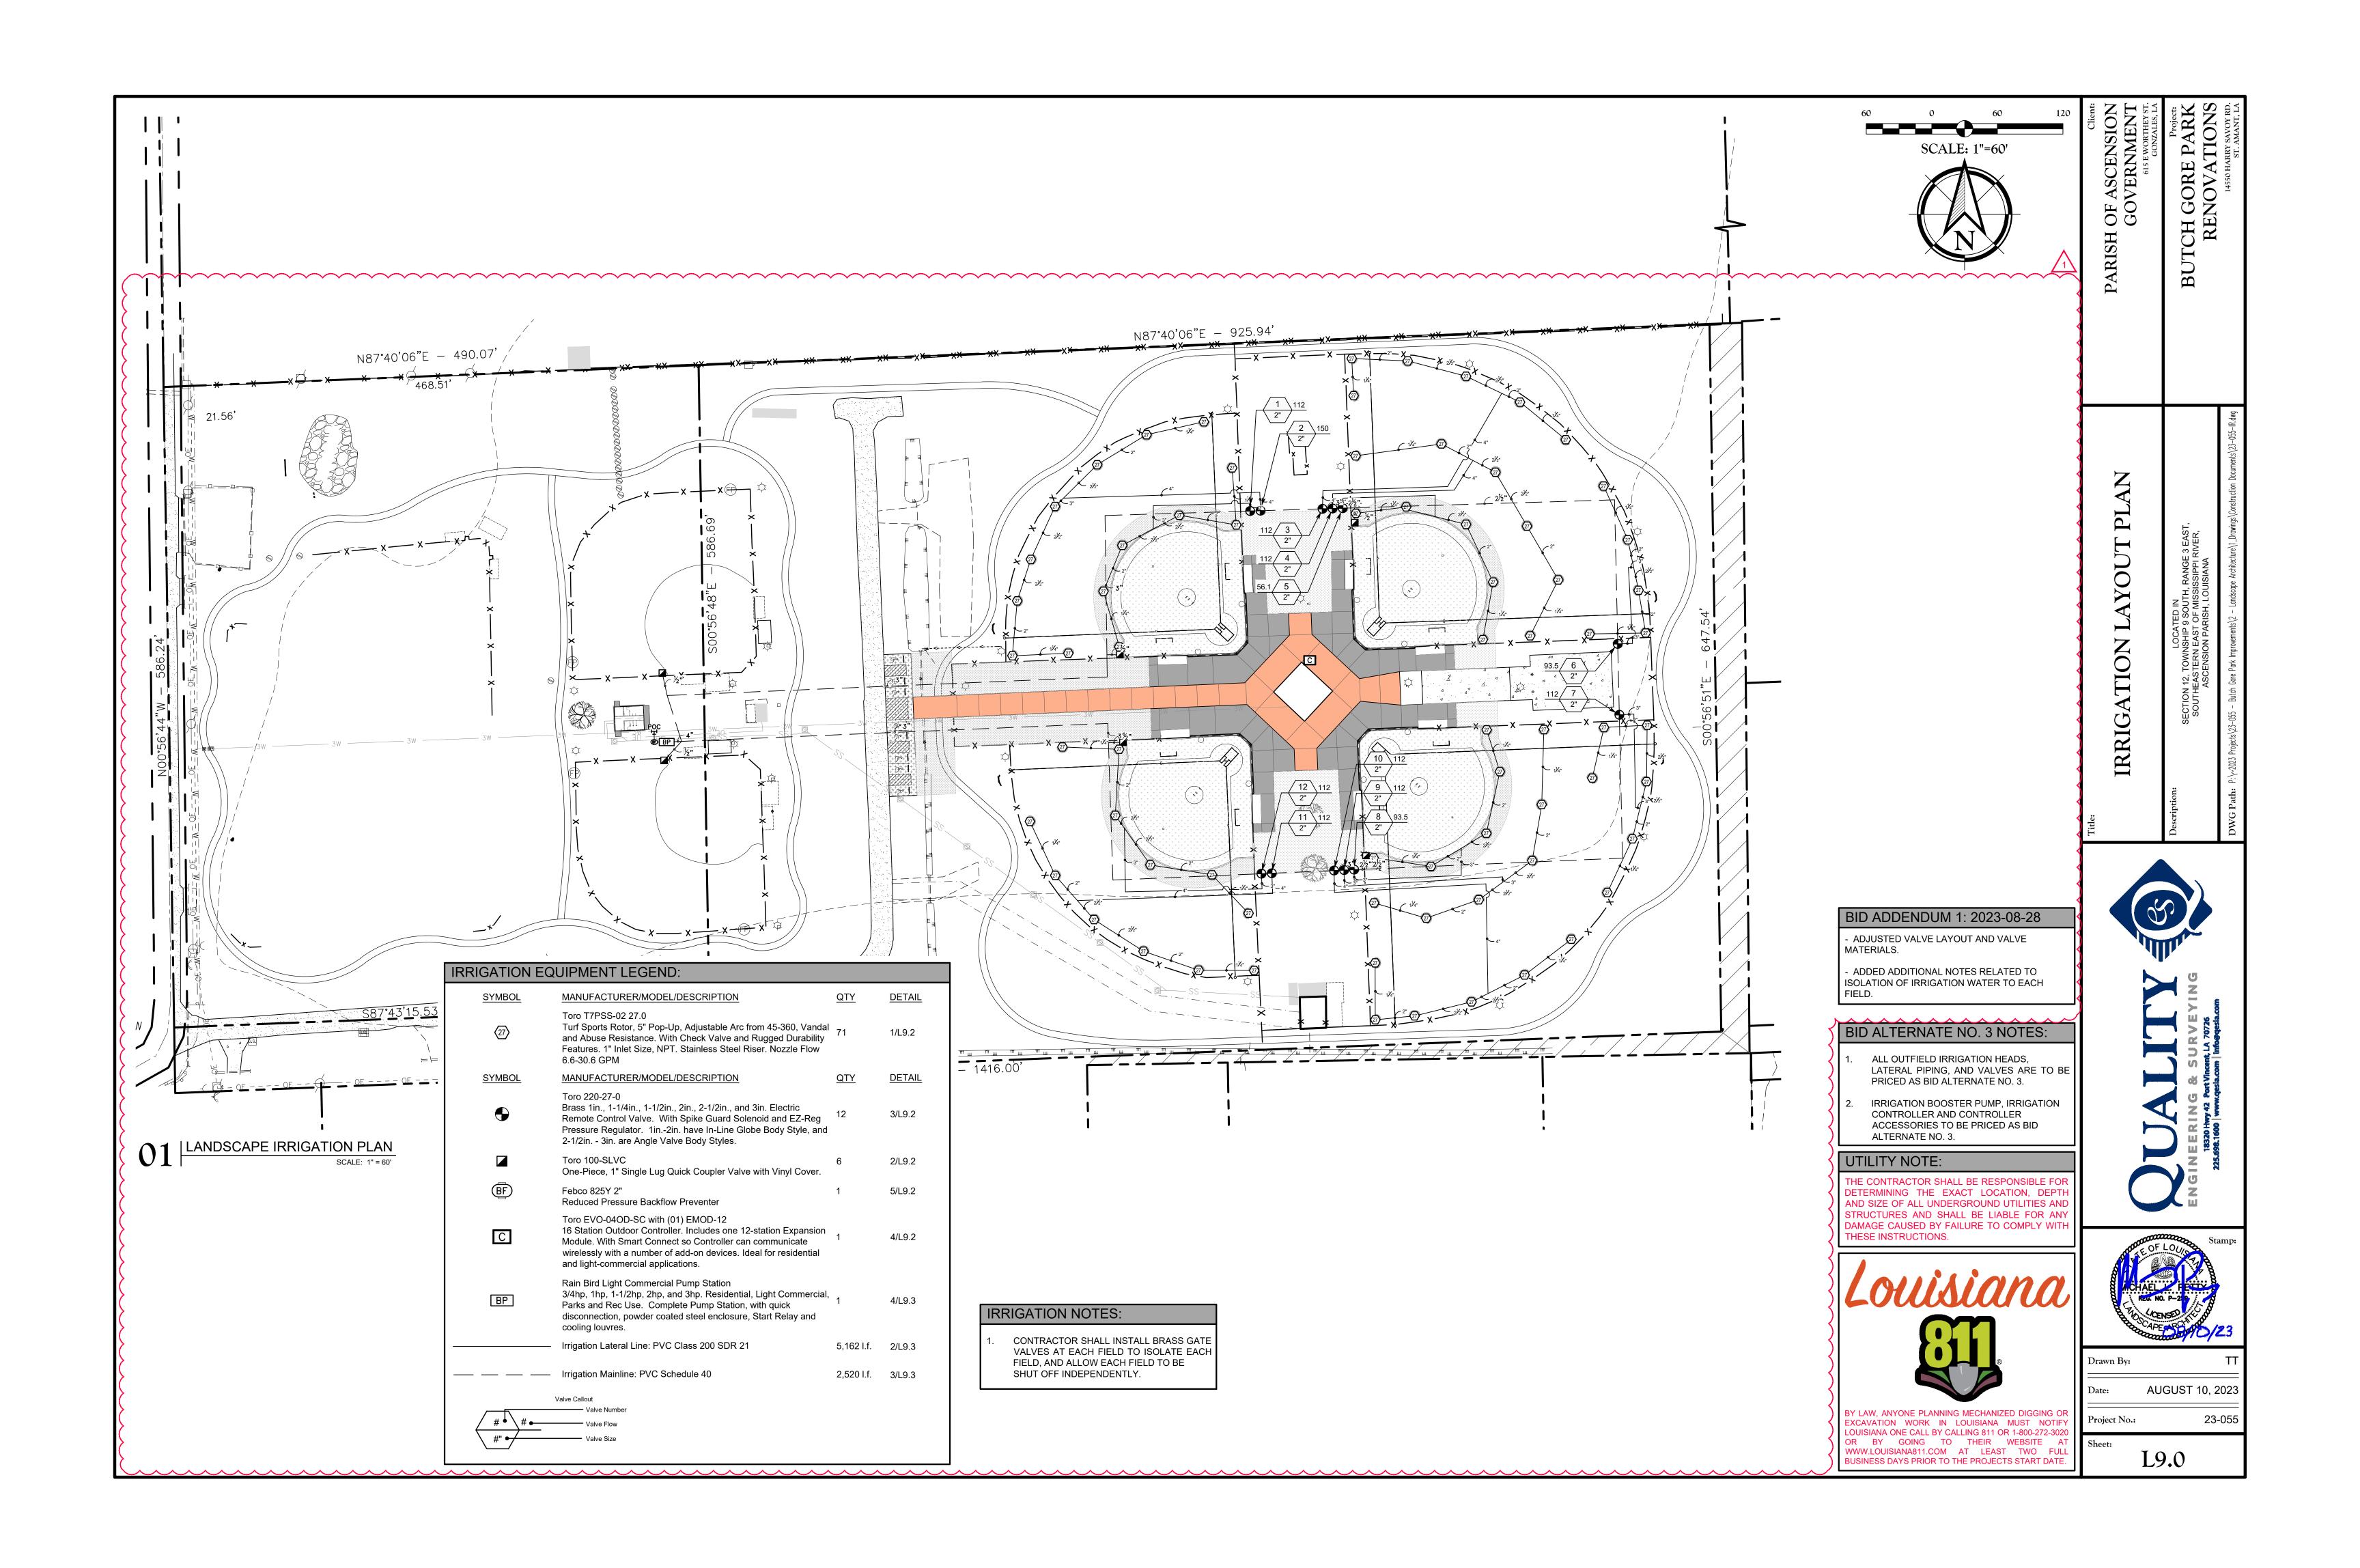

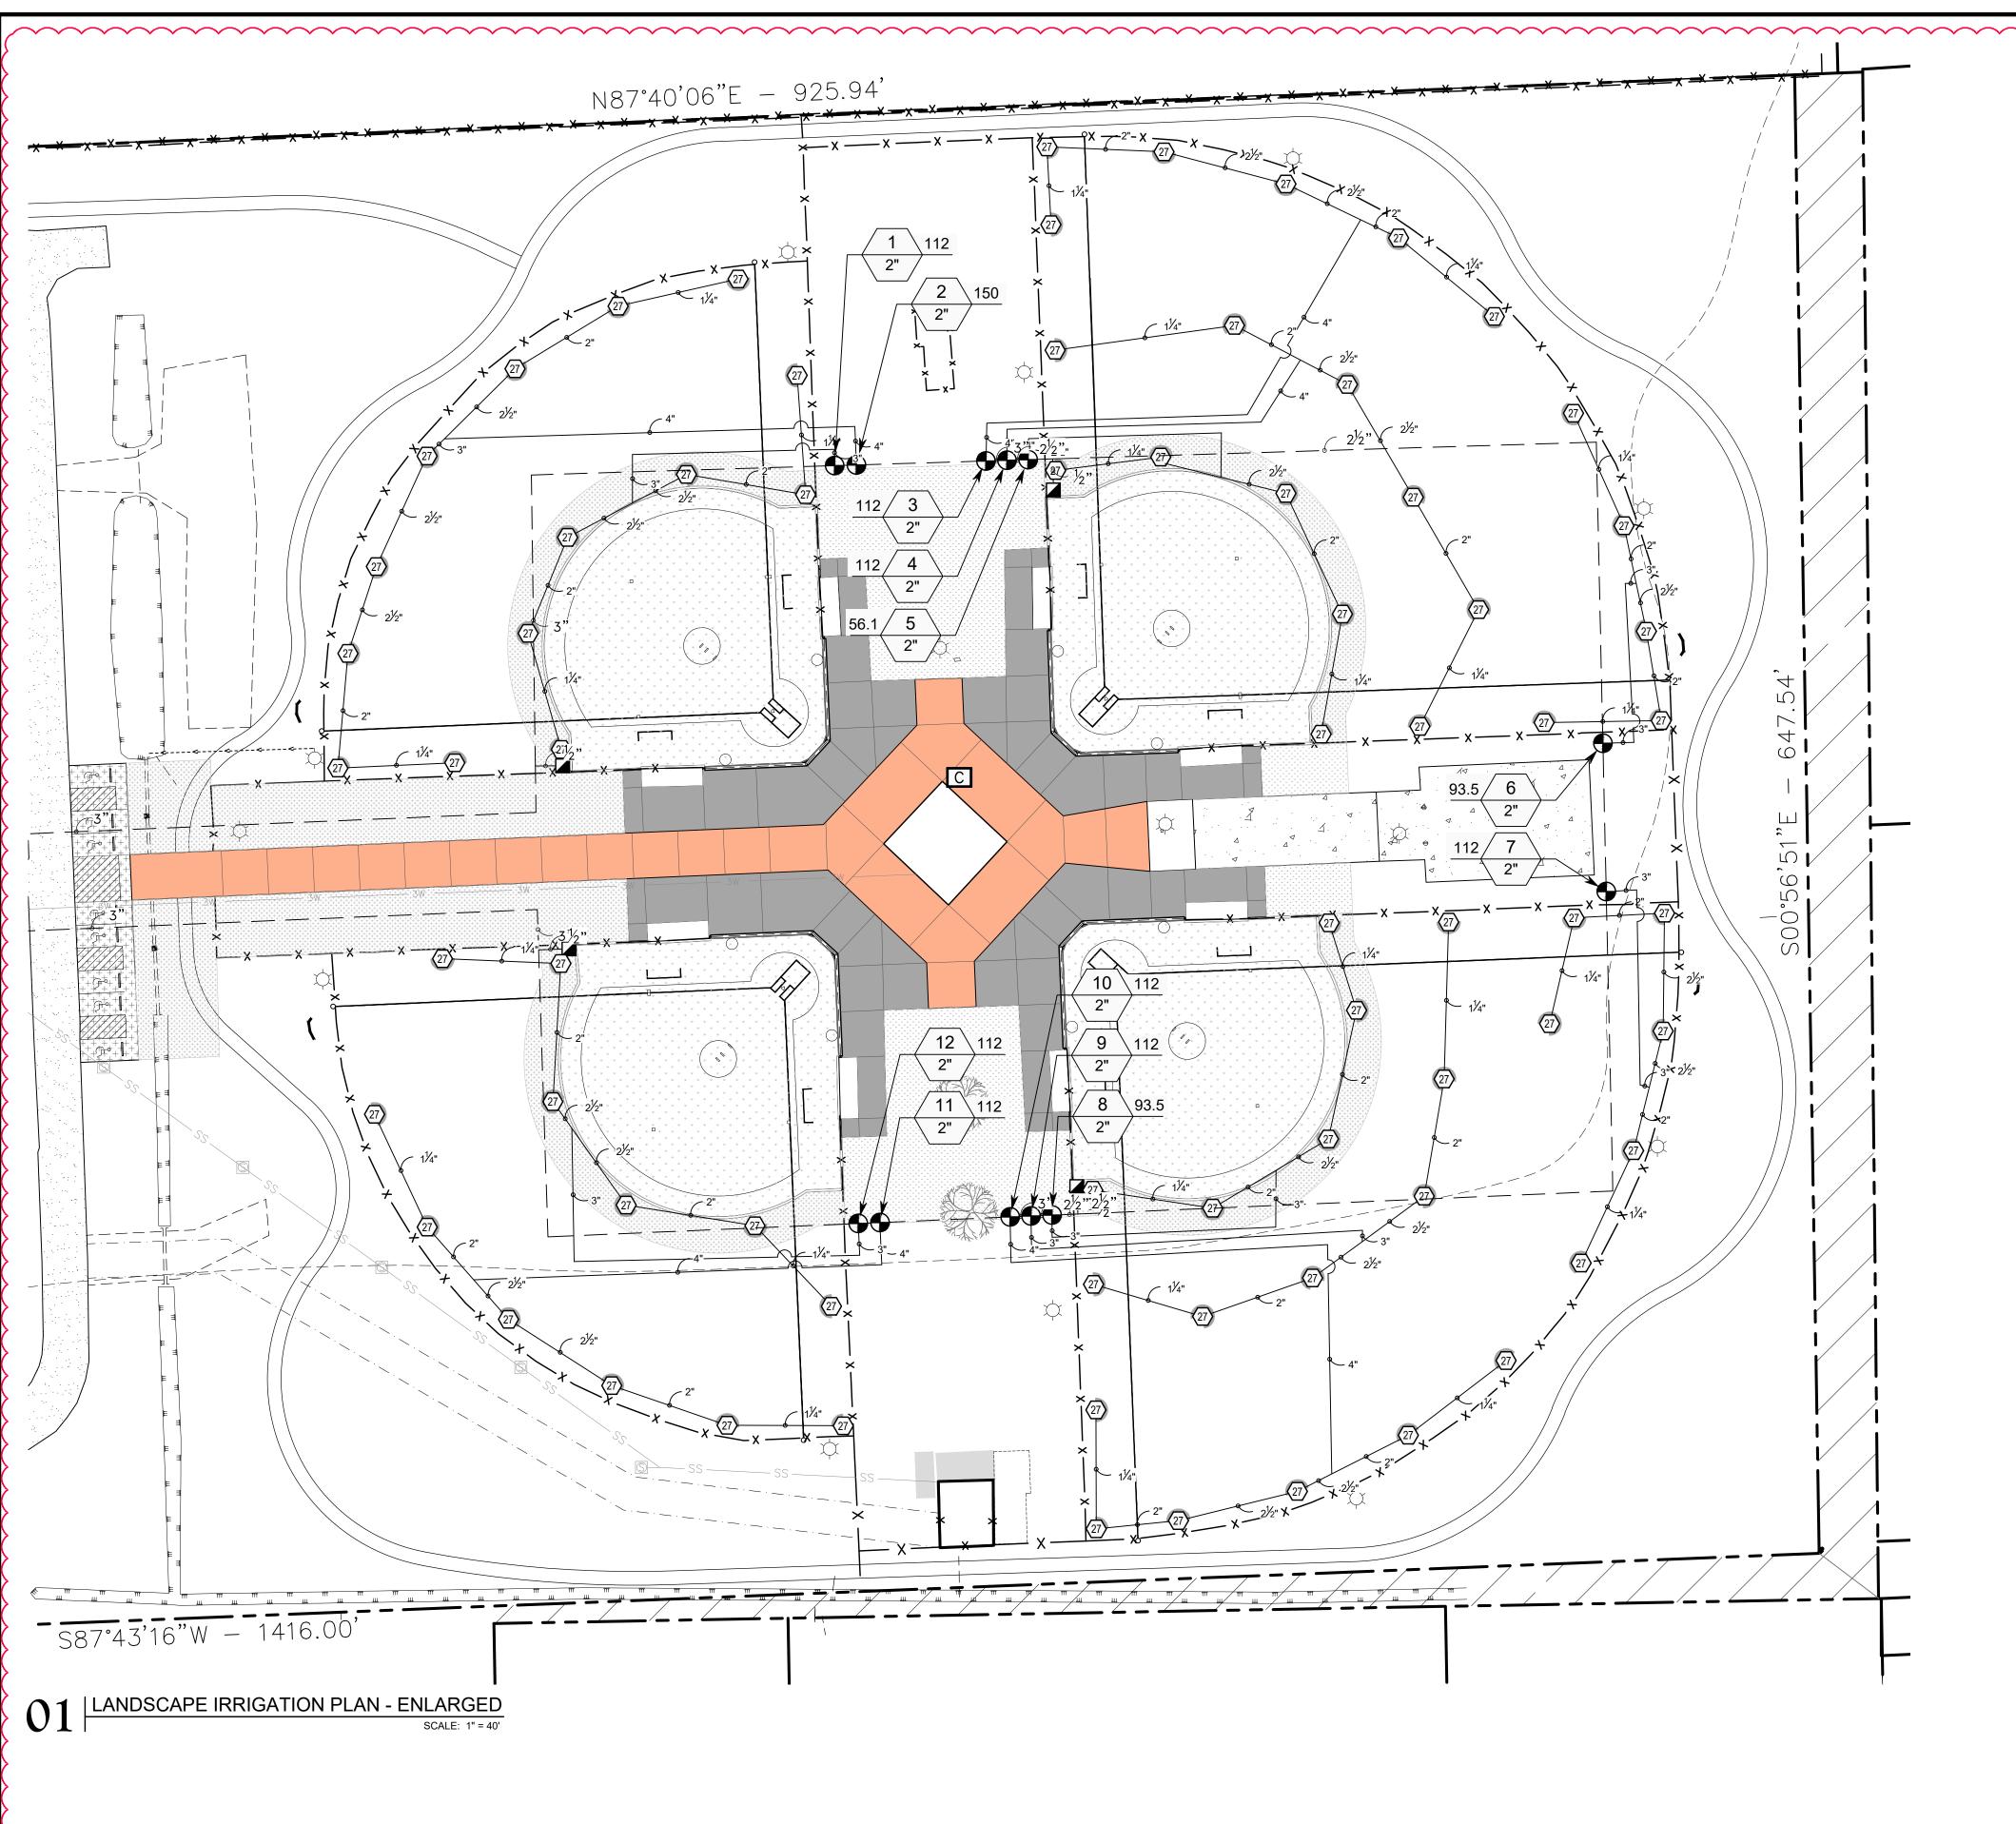

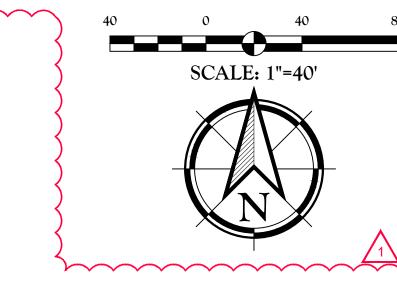

PARISH OF ASCENSIC GOVERNMER

IRRIGATION EQ	UIPMENT LEGEND:		
SYMBOL	MANUFACTURER/MODEL/DESCRIPTION	QTY	DETAIL
27)	Toro T7PSS-02 27.0 Turf Sports Rotor, 5" Pop-Up, Adjustable Arc from 45-360, Vandal and Abuse Resistance. With Check Valve and Rugged Durability Features. 1" Inlet Size, NPT. Stainless Steel Riser. Nozzle Flow 6.6-30.6 GPM	71	1/L9.2
SYMBOL	MANUFACTURER/MODEL/DESCRIPTION	<u>QTY</u>	<u>DETAIL</u>
•	Toro 220-27-0 Brass 1in., 1-1/4in., 1-1/2in., 2in., 2-1/2in., and 3in. Electric Remote Control Valve. With Spike Guard Solenoid and EZ-Reg Pressure Regulator. 1in2in. have In-Line Globe Body Style, and 2-1/2in 3in. are Angle Valve Body Styles.	12	3/L9.2
	Toro 100-SLVC One-Piece, 1" Single Lug Quick Coupler Valve with Vinyl Cover.	6	2/L9.2
BF	Febco 825Y 2" Reduced Pressure Backflow Preventer	1	5/L9.2
С	Toro EVO-04OD-SC with (01) EMOD-12 16 Station Outdoor Controller. Includes one 12-station Expansion Module. With Smart Connect so Controller can communicate wirelessly with a number of add-on devices. Ideal for residential and light-commercial applications.	1	4/L9.2
ВР	Rain Bird Light Commercial Pump Station 3/4hp, 1hp, 1-1/2hp, 2hp, and 3hp. Residential, Light Commercial, Parks and Rec Use. Complete Pump Station, with quick disconnection, powder coated steel enclosure, Start Relay and cooling louvres.	1	4/L9.3
	Irrigation Lateral Line: PVC Class 200 SDR 21	5,162 l.f.	2/L9.3
	Irrigation Mainline: PVC Schedule 40	2,520 l.f.	3/L9.3
# • # •	Valve Callout Valve Number Valve Flow		

BID ADDENDUM 1: 2023-08-28

- ADJUSTED VALVE LAYOUT AND VALVE MATERIALS.

- ADDED ADDITIONAL NOTES RELATED TO ISOLATION OF IRRIGATION WATER TO EACH FIELD.

IRRIGATION NOTES:

CONTRACTOR SHALL INSTALL BRASS GATE VALVES AT EACH FIELD TO ISOLATE EACH FIELD, AND ALLOW EACH FIELD TO BE SHUT OFF INDEPENDENTLY.

BID ALTERNATE NO. 3 NOTES:


- ALL OUTFIELD IRRIGATION HEADS, LATERAL PIPING, AND VALVES ARE TO BE PRICED AS BID ALTERNATE NO. 3.
- IRRIGATION BOOSTER PUMP, IRRIGATION CONTROLLER AND CONTROLLER ACCESSORIES TO BE PRICED AS BID ALTERNATE NO. 3.

UTILITY NOTE:

THE CONTRACTOR SHALL BE RESPONSIBLE FOR DETERMINING THE EXACT LOCATION, DEPTH AND SIZE OF ALL UNDERGROUND UTILITIES AND STRUCTURES AND SHALL BE LIABLE FOR ANY DAMAGE CAUSED BY FAILURE TO COMPLY WITH THESE INSTRUCTIONS.



BY LAW, ANYONE PLANNING MECHANIZED DIGGING OR EXCAVATION WORK IN LOUISIANA MUST NOTIFY LOUISIANA ONE CALL BY CALLING 811 OR 1-800-272-3020 OR BY GOING TO THEIR WEBSITE AT WWW.LOUISIANA811.COM AT LEAST TWO FULL BUSINESS DAYS PRIOR TO THE PROJECTS START DATE.

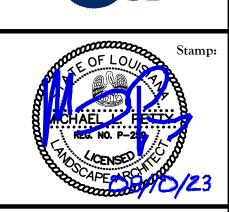



Drawn By: TT

Date: AUGUST 10, 2023

ect No.: 23-055

L9.1

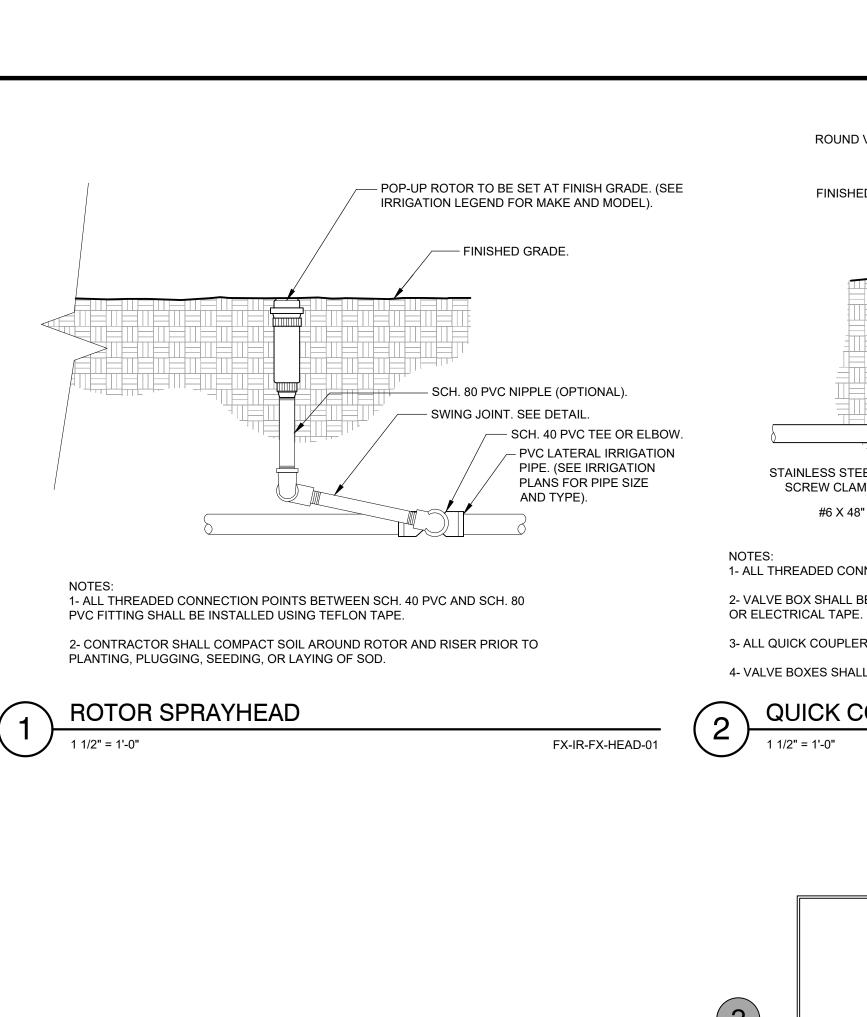

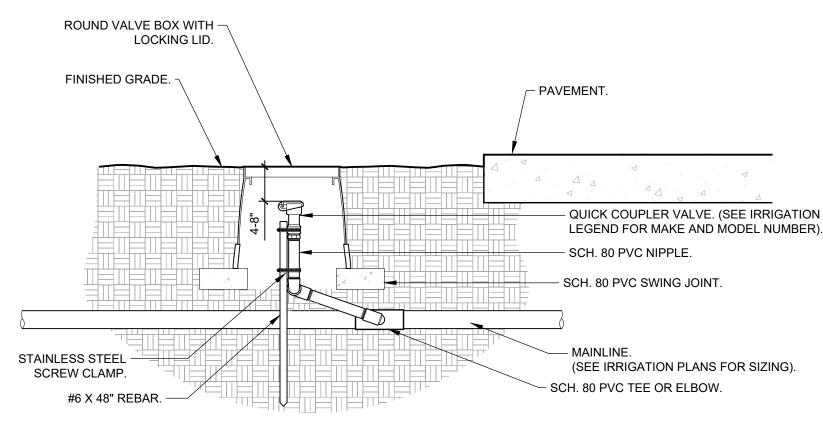

1- ALL THREADED CONNECTIONS SHALL BE INSTALLED USING TEFLON TAPE.

2- VALVE BOX SHALL BE WRAPPED WITH A MINIMUM 3 MIL THICK PLASTIC AND SECURED TO THE VALVE BOX USING DUCT TAPE

3- ALL QUICK COUPLERS SHALL BE INSTALLED A MINIMUM OF 18" OFF OF THE MAINLINE.

4- VALVE BOXES SHALL BE LOCATED IN PLANTING AREAS.

QUICK COUPLER VALVE

ENCLOSURE SIZE PLUS 6"

LENGTH AND WIDTH

2" ABOVE FINISH 2" MINIMUM, 4" MAXIMUM GRADE AT SHRUBS. BELOW TOP OF BOX. 10X15 RECTANGULAR VALVE BOX. -3/4" ABOVE FINISH | REMOTE CONTROL VALVE, ONE PER BOX.-GRADE AT LAWN. PLASTIC I.D. TAG AT EACH VALVE. -WATER PROOF WIRE CONNECTORS ON_I 30" LOOPED WIRES. OUTLET PIPE SAME SIZE AS VALVE, 24" MIN. TO FIRST FITTING. 45 DOWN AS REQ. TO LATERAL INCREASE LATERAL LINE AS PER IRRIGATION PLAN. CONCRETE BRICK SUPPORT, TWO ON EACH SIDE. 6" THICK LAYER OF PEA -SCHEDULE 80 RISER. MAIN LINE. —

ELECTRIC REMOTE CONTROL VALVE

FX-IR-FX-RCV-04

2023-08-29 09:53

(1) REDUCED **PRESSURE** BACKFLOW DEVICE AS SPECIFIED 2 BACKFLOW SPECIFIED CONCRETE EACH 4 GALVANIZED

REDUCED PRESSURE BACKFLOW W/ ENCLOSURE

1.36 in/h

ENCLOSURE AS (3) CONCRETE THRUST BLOCKS, 90 LBS OF

FX-IR-FX-QUIC-01

NIPPLES AND ELL AS REQUIRED

(5) GALVANIZED UNIONS AT EACH

6 GALVANIZED RISERS 7 4" THICK MIN. CONCRETE PAD

(8) GALVANIZED ELL AND NIPPLE, **TYPICAL**

9 PVC COUPLER OR REDUCER AS REQUIRED, TYPICAL

FX-IR-FX-BACK-04

CRITICAL ANALYSIS Generated:

P.O.C. NUMBER: 01 Water Source Information:

FLOW AVAILABLE Point of Connection Size:

170.11 GPM Flow Available PRESSURE AVAILABLE Static Pressure at POC: 75 PSI

Booster Pump pressure provided: Pressure Available: **DESIGN ANALYSIS**

Maximum Station Flow: 149.6 GPM 170.11 GPM Flow Available at POC Residual Flow Available: 20.51 GPM 40 PSI Design Pressure: 3.3 PSI Friction Loss:

0.33 PSI Fittings Loss: 0 PSI Elevation Loss: 9.97 PSI Loss through Valve: Pressure Req. at Critical Station: 53.6 PSI 0.79 PSI Loss for Fittings: 7.87 PSI Loss for Main Line: Loss for POC to Valve Elevation: 0 PSI 13.1 PSI Loss for Backflow: Critical Station Pressure at POC: 75.4 PSI Pressure Available:

Residual Pressure Available:

BID ADDENDUM 1: 2023-08-28

REVISED VALVE SCHEDULE.

19.6 PSI


REVISED REMOTE CONTROL VALVE DETAIL

REVISED CRITICAL ANALYSIS CALCULATIONS BASED ON NEW VALVE LAYOUT.

- ALL OUTFIELD IRRIGATION HEADS, LATERAL PIPING, AND VALVES ARE TO BE
- CONTROLLER AND CONTROLLER ACCESSORIES TO BE PRICED AS BID ALTERNATE NO. 3.



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RRIG,

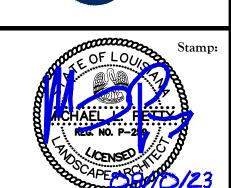Drawn By: AUGUST 10, 2023

23-055 Project No.:

L9.2

	WALL MOUNT CONTROLLER
(4)	

Toro 220-27-0 2"

Common Wire

LONG SWEEP ELL.

SET CONTROLLER 60" ABOVE

CONTROLLER AS SPECIFIED. --

SECURELY BOLT CONTROLLER

TO WALL. INSTALL BACKUP

BATTERIES AS REQUIRED.

GROUND AS PER MFG.

1/2" DIAMETER RIGID -

STEEL CONDUIT FOR

110 VAC ELECTRICAL

FINISHED GRADE.

SOURCE. INSTALL AS

PER LOCAL ELECTRICAL

SPECIFICATIONS.

CODES.

FINISHED GRADE UNLESS

OTHERWISE NOTED.

1" = 1'-0"

FX-IR-FX-CONT-07

Turf Rotor 112.2 6

VALVE SCHEDULE <u>NUMBER</u> FRICTION LOSS VALVE LOSS PSI PSI @ POC 67.7 1.85 in/h Toro 220-27-0 2" 234.9 Toro 220-27-0 Turf Rotor 149.6 565.6 3.63 9.97 53.6 75.4 1.56 in/h 112.2 489.2 178.1 2.82 6.92 49.7 1.77 in/h Toro 220-27-0 Turf Rotor 68.3 472.5 2.84 6.92 49.7 Toro 220-27-0 Turf Rotor 169.0 68.4 0.79 in/h 2.54 44.8 Toro 220-27-0 Turf Rotor 276.8 159.7 2.31 58.6 1.86 in/h 47.3 Toro 220-27-0 Turf Rotor 518.9 2.14 5.19 65.3 1.73 in/h Toro 220-27-0 2" Turf Rotor 366.5 583.8 3.22 50.1 70.5 1.39 in/h 341.3 47.6 Toro 220-27-0 2" Turf Rotor 960.9 2.44 5.19 63.9 1.97 in/h 461.2 3.77 50.7 Toro 220-27-0 2" Turf Rotor 970.0 68.7 0.81 in/h 2.77 49.7 Toro 220-27-0 2" Turf Rotor 112.2 519.5 979.2 6.92 67.6 1.76 in/h 472.7 Turf Rotor 112.2 6 1,036 49.7 Toro 220-27-0 2" 2.79 6.92 67.4 1.59 in/h

1,046

2,520

476.8

- 1 1/2" DIAMETER RIGID

SERVICE

3.89

1" = 1'-0"

6.92

50.8 68.5

STEEL CONDUIT FOR

RCV WIRES.

-USE PVC SCH. 40

BELOW GRADE.



PRICED AS BID ALTERNATE NO. 3.

IRRIGATION BOOSTER PUMP, IRRIGATION

UTILITY NOTE:

THE CONTRACTOR SHALL BE RESPONSIBLE FOR DETERMINING THE EXACT LOCATION, DEPTH AND SIZE OF ALL UNDERGROUND UTILITIES AND STRUCTURES AND SHALL BE LIABLE FOR ANY DAMAGE CAUSED BY FAILURE TO COMPLY WITH THESE INSTRUCTIONS.

